


BIM Transmittal Disclaimer

McBains Ltd makes no express or implied warranties with respect to the character, function, or capabilities of the data (inclusive of 3rd party data incorporated within), or the suitability of the data for any particular purpose beyond those originally intended by McBains Ltd. please refer to our standard terms and conditions for further details.

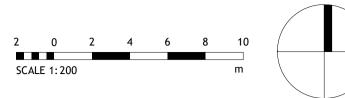


SITE BOUNDARY


21.04.23 13.06.22 25.05.22 Date CD MEPB

05/05/22 1:200 @ A1 Scale @ A1


5th Fl, 26 Finsbury Square London EC2A 1DS +44 (0)20 7786 7900 mcbains.co.uk

HARPR - MCB - XX - SI - DR - A - 0101

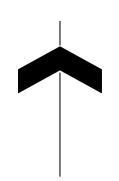

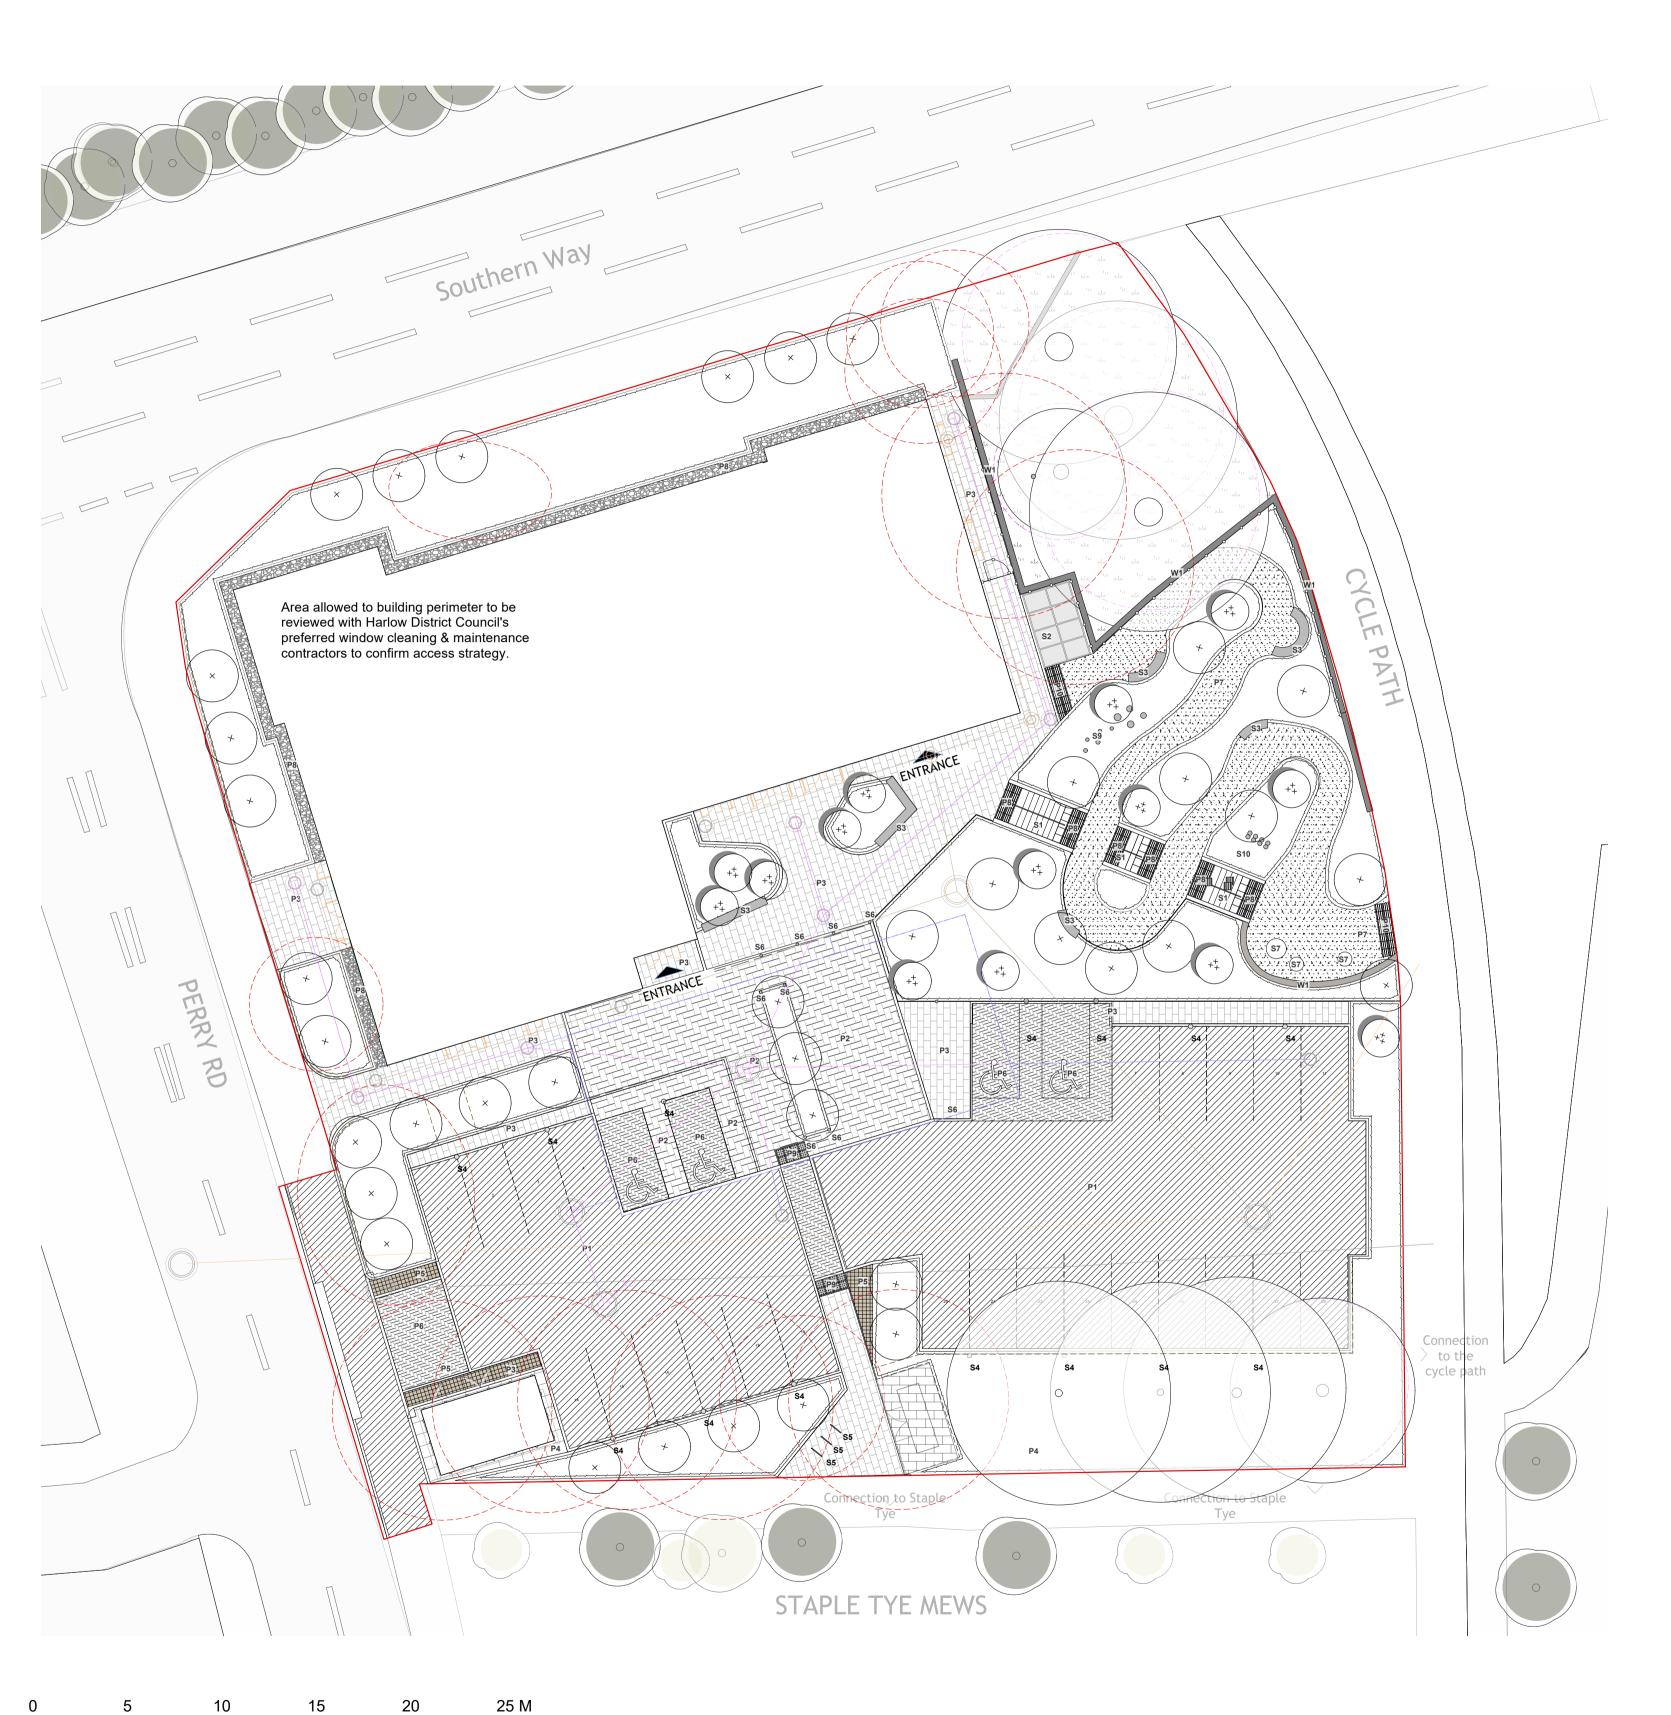

KEY CONT. Fencing and Structures Planning Application Boundary Pedestrian Restraint System To W1 Wall. Colour to match building. To engineers' specification. See Note 12. Proposed Gates Colour to mach building. See note 12. +12.345m Proposed Retaining Wall [Ref W1] Drainage Coordination Proposed Attenuation Tank Indicative Root Barrier TBC with service coordination Proposed Fowl Water Sewer and Manhole To drainage engineer's specification Proposed Surface Water Sewer and Manhole To drainage engineer's specification Existing Fowl Water Sewer and Manhole To drainage engineer's specification Planting Existing Surface Water Sewer and Manhole To drainage engineer's specification

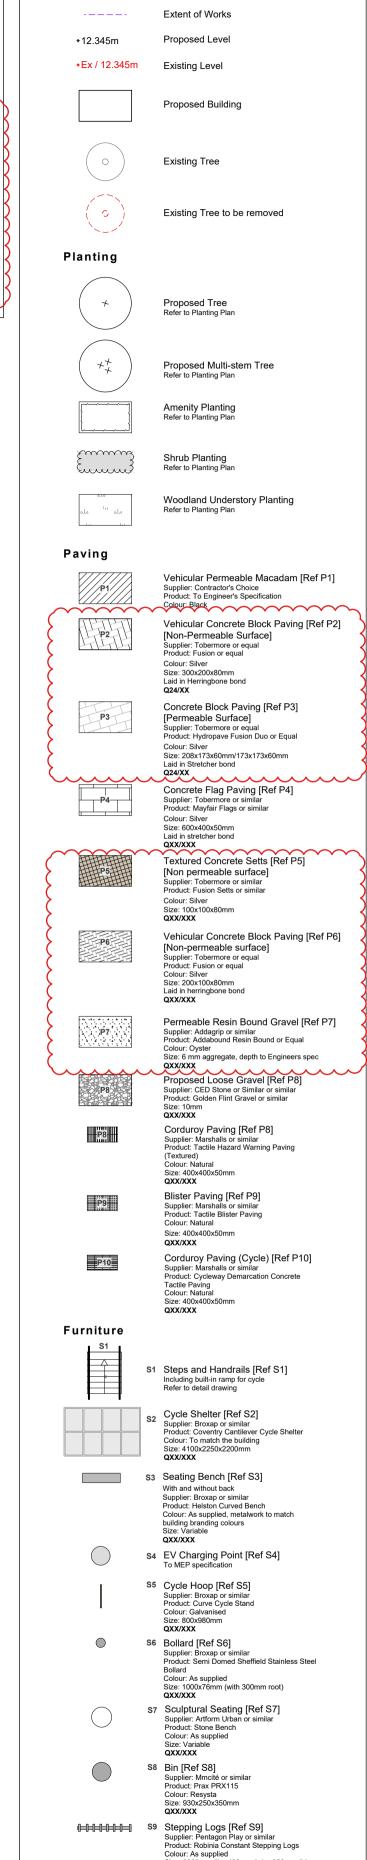

	(+)		Proposed Tree Refer to Planting Plan				e Surgeon.		Para ta Kanadha a kharakha a		
							on shown outsic not part of this s		line is for illustrative of works	e purpo	ses
	$\begin{pmatrix} + \\ + \\ + \end{pmatrix}$		Proposed Multi-stem Tree		•		works by others				
			Refer to Planting Plan				•		ended to be special		•
			Amenity Planting Refer to Planting Plan	sy	ste	ms/gate	es/handrails) and	d all st	(including pedestria treet furniture. Spec e and submit packa	cialist	ain
			Shrub Planting Refer to Planting Plan	ar	chi	tect's ap	oproval prior to p	rocur	ement and manufactorical from Landsca	cture.	nitect
	818 818 111 818		Woodland Understory Planting Refer to Planting Plan			•	uarding and hea ands in accordar		d safety issues. th TBC SPD3, to be	∍ 1.0m	apart.
	Davis										
'	Paving		Validada Damarakka Marada a (D. (D4)								
	P1		Vehicular Permeable Macadam [Ref P1] Supplier: Contractor's Choice Product: To Engineer's Specification								
		~	Colour: Black Vehicular Concrete Block Paving [Ref P2]	\							
{	P2		[Non-Permeable Surface] Supplier: Tobermore or equal	3							
}			Product: Fusion or equal Colour: Silver Size: 300x200x80mm	3							
}			Laid in Herringbone bond Q24/XX	}							
{	P3		Concrete Block Paving [Ref P3] [Permeable Surface]								
{			Supplier: Tobermore or equal Product: Hydropave Fusion Duo or Equal Colour: Silver								
}			Size: 208x173x60mm/173x173x60mm Laid in Stretcher bond Q24/XX	}							
			Concrete Flag Paving [Ref P4] Supplier: Tobermore or similar								
	P4		Product: Mayfair Flags or similar Colour: Silver								
			Size: 600x400x50mm Laid in stretcher bond QXX/XXX								
	P5	\sim	Textured Concrete Setts [Ref P5] [Non permeable surface])							
{			Supplier: Tobermore or similar Product: Fusion Setts or similar	3							
}			Colour: Silver Size: 100x100x80mm QXX/XXX	}							
\	P6		Vehicular Concrete Block Paving [Ref P6]	\							
}			[Non-permeable surface] Supplier: Tobermore or equal Product: Fusion or equal	3							
{			Colour: Silver Size: 200x100x80mm Laid in herringbone bond	}							
}			QXX/XXX								
}	:P7		Permeable Resin Bound Gravel [Ref P7] Supplier: Addagrip or similar Product: Addabound Resin Bound or Equal								
{	[Colour: Oyster Size: 6 mm aggregate, depth to Engineers spec QXX/XXX	3							
	P8		Proposed Loose Gravel [Ref P8] Supplier: CED Stone or Similar or similar Product: Golden Flint Gravel or similar Size: 10mm								
	P8		QXX/XXX Corduroy Paving [Ref P8]								
	IIIIIIIIIIIIIIIIIIIIIIIIIIIIIIIIIIIIIII		Supplier: Marshalls or similar Product: Tactile Hazard Warning Paving (Textured)								
			Colour: Natural Size: 400x400x50mm QXX/XXX								
	P9		Blister Paving [Ref P9] Supplier: Marshalls or similar								
			Product: Tactile Blister Paving Colour: Natural Size: 400x400x50mm								
	P10		QXX/XXX Corduroy Paving (Cycle) [Ref P10]		R	Refer to	Risk Assessmer	nt			
			Supplier: Marshalls or similar Product: Cycleway Demarcation Concrete Tactile Paving			ocume 40-ALA	nt- -00-RR-001				
			Colour: Natural Size: 400x400x50mm QXX/XXX								
F	Furniture			ID	R	RISK			MITIGATION		DATE MITIGATE
	\$1	0.4	Ohan a and Handralla (Daf Od)		F	RES	IDUAL	PR	OJECT R	ISK	S
		31	Steps and Handrails [Ref S1] Including built-in ramp for cycle Refer to detail drawing							$\overline{}$	
		S2	Cycle Shelter [Ref S2]	03/05	2023	3 P06			nning, revised drainage structed by McBains Tue	GW	KS
Į		32	Supplier: Broxap or similar Product: Coventry Cantilever Cycle Shelter Colour: To match the building	27/07/	2022	2 P05	25/04/23 [CR, PO F	PO30497	'11]	CJW	KS
Į			Size: 4100x2250x2200mm QXX/XXX		2022		information to include	de:	o permeable macadam	0011	
		S3	Seating Bench [Ref S3] With and without back	20/07/	2022	2 P04	Issued for Planning information to include Revised tracking f	de:	·	KS	
			Supplier: Broxap or similar Product: Helston Curved Bench Colour: As supplied, metalwork to match				- Retention of existi - Modifications to la	ng trees	/ relocation of generator ease of access to bin		
			building branding colours Size: Variable QXX/XXX	DA		REV	store DESCRIPTION OF	DEVISIO	NI.	DRAWN	APPROV
		S4	EV Charging Point [Ref S4] To MEP specification			11.24			SIONS	BY	BY
		S5	Cycle Hoop [Ref S5] Supplier: Broxap or similar				NL	VIO			
	l		Product: Curve Cycle Stand Colour: Galvanised Size: 800x980mm	S	AT	US					
		S6	QXX/XXX Bollard [Ref S6]	S	2	- Is	sued for l	Plan	ning Approv	<i>val</i>	
			Supplier: Broxap or similar Product: Semi Domed Sheffield Stainless Steel Bollard						Ares Landscape	Archit	ects LT
			Colour: As supplied Size: 1000x76mm (with 300mm root) QXX/XXX				res		Gatecrasher, 51 Eyre Lane		
		S 7	Sculptural Seating [Ref S7] Supplier: Artform Urban or similar				DSCAPE		Sheffield S1 4RB		
			Product: Stone Bench Colour: As supplied Size: Variable				HITECTS		t: 0114 276 20 e: hello@aresd		o.uk
		S8	QXX/XXX Bin [Ref S8]						w: ares.eu.com	_	
			Supplier: Mmcité or similar Product: Prax PRX115 Colour: Resysta			NT :	_				
		_	Size: 930x250x350mm QXX/XXX		IC	Bain	5				
		S9	Stepping Logs [Ref S9] Supplier: Pentagon Play or similar Product: Robinia Constant Stepping Logs		-	IFOT =	1 F .				
			Colour: As supplied Size: 2200mm (I) x 400mm (w) x 650mm (h) QXX/XXX			rv R					
	8888	S10	Weaving Logs [Ref S10] Supplier: Pentagon Play or similar		٦í	ry R	Juu				
	~ U		Product: Robinia Walk and Stretch (set of 8) Colour: As supplied Size: 1850mm (h)		RAV	VING TIT	 LE :				
			QXX/XXX					al A	rrangement		
				_	-				<u> </u>		

Note

1. Do not scale from this drawing

2. To be read in conjunction with 740-ALA-XX-XX-RR-L-001_ Risk Assessment and Register

3. To be read in conjunction with all other Landscape Architect's

drawings: - 740-ALA-00-00-DR-L-0001_Landscape Illustrative Masterplan

- 740-ALA-00-00-DR-L-0003_Planting Plan

- 740-ALA-00-00-DR-L-0004_Site Sections 4. To be read in conjunction with all other disciplines drawings

and specifications

5. All sub bases to retaining features, walls, paving build-ups to Project Engineers details. Formations levels are to be inspected

and approved by the Project Engineer

6. Drainage design, manhole cover positions & final levels to becoordinated with Drainage Engineers

7. Lighting design, to be coordinated with M&E details

8. Landscape contractor is responsible for all area take offs. Areas and quantities are shown for information only 9. Any work to existing trees to be carried out by a suitability

qualified Tree Surgeon. s for illustrative purposes

s Landscape Architects LTD Eyre Lane neffield I 4RB : 0114 276 2000 e: hello@aresdesign.co.uk v: ares.eu.com

PAPER SIZE :

1:200

A1 DRAWING NUMBER:


740-ALA-00-XX-DR-L-0002


STATUS: REVISION:

APPROVED BY:


17/05/2022

ALA PROJECT CODE: ALA740

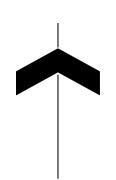

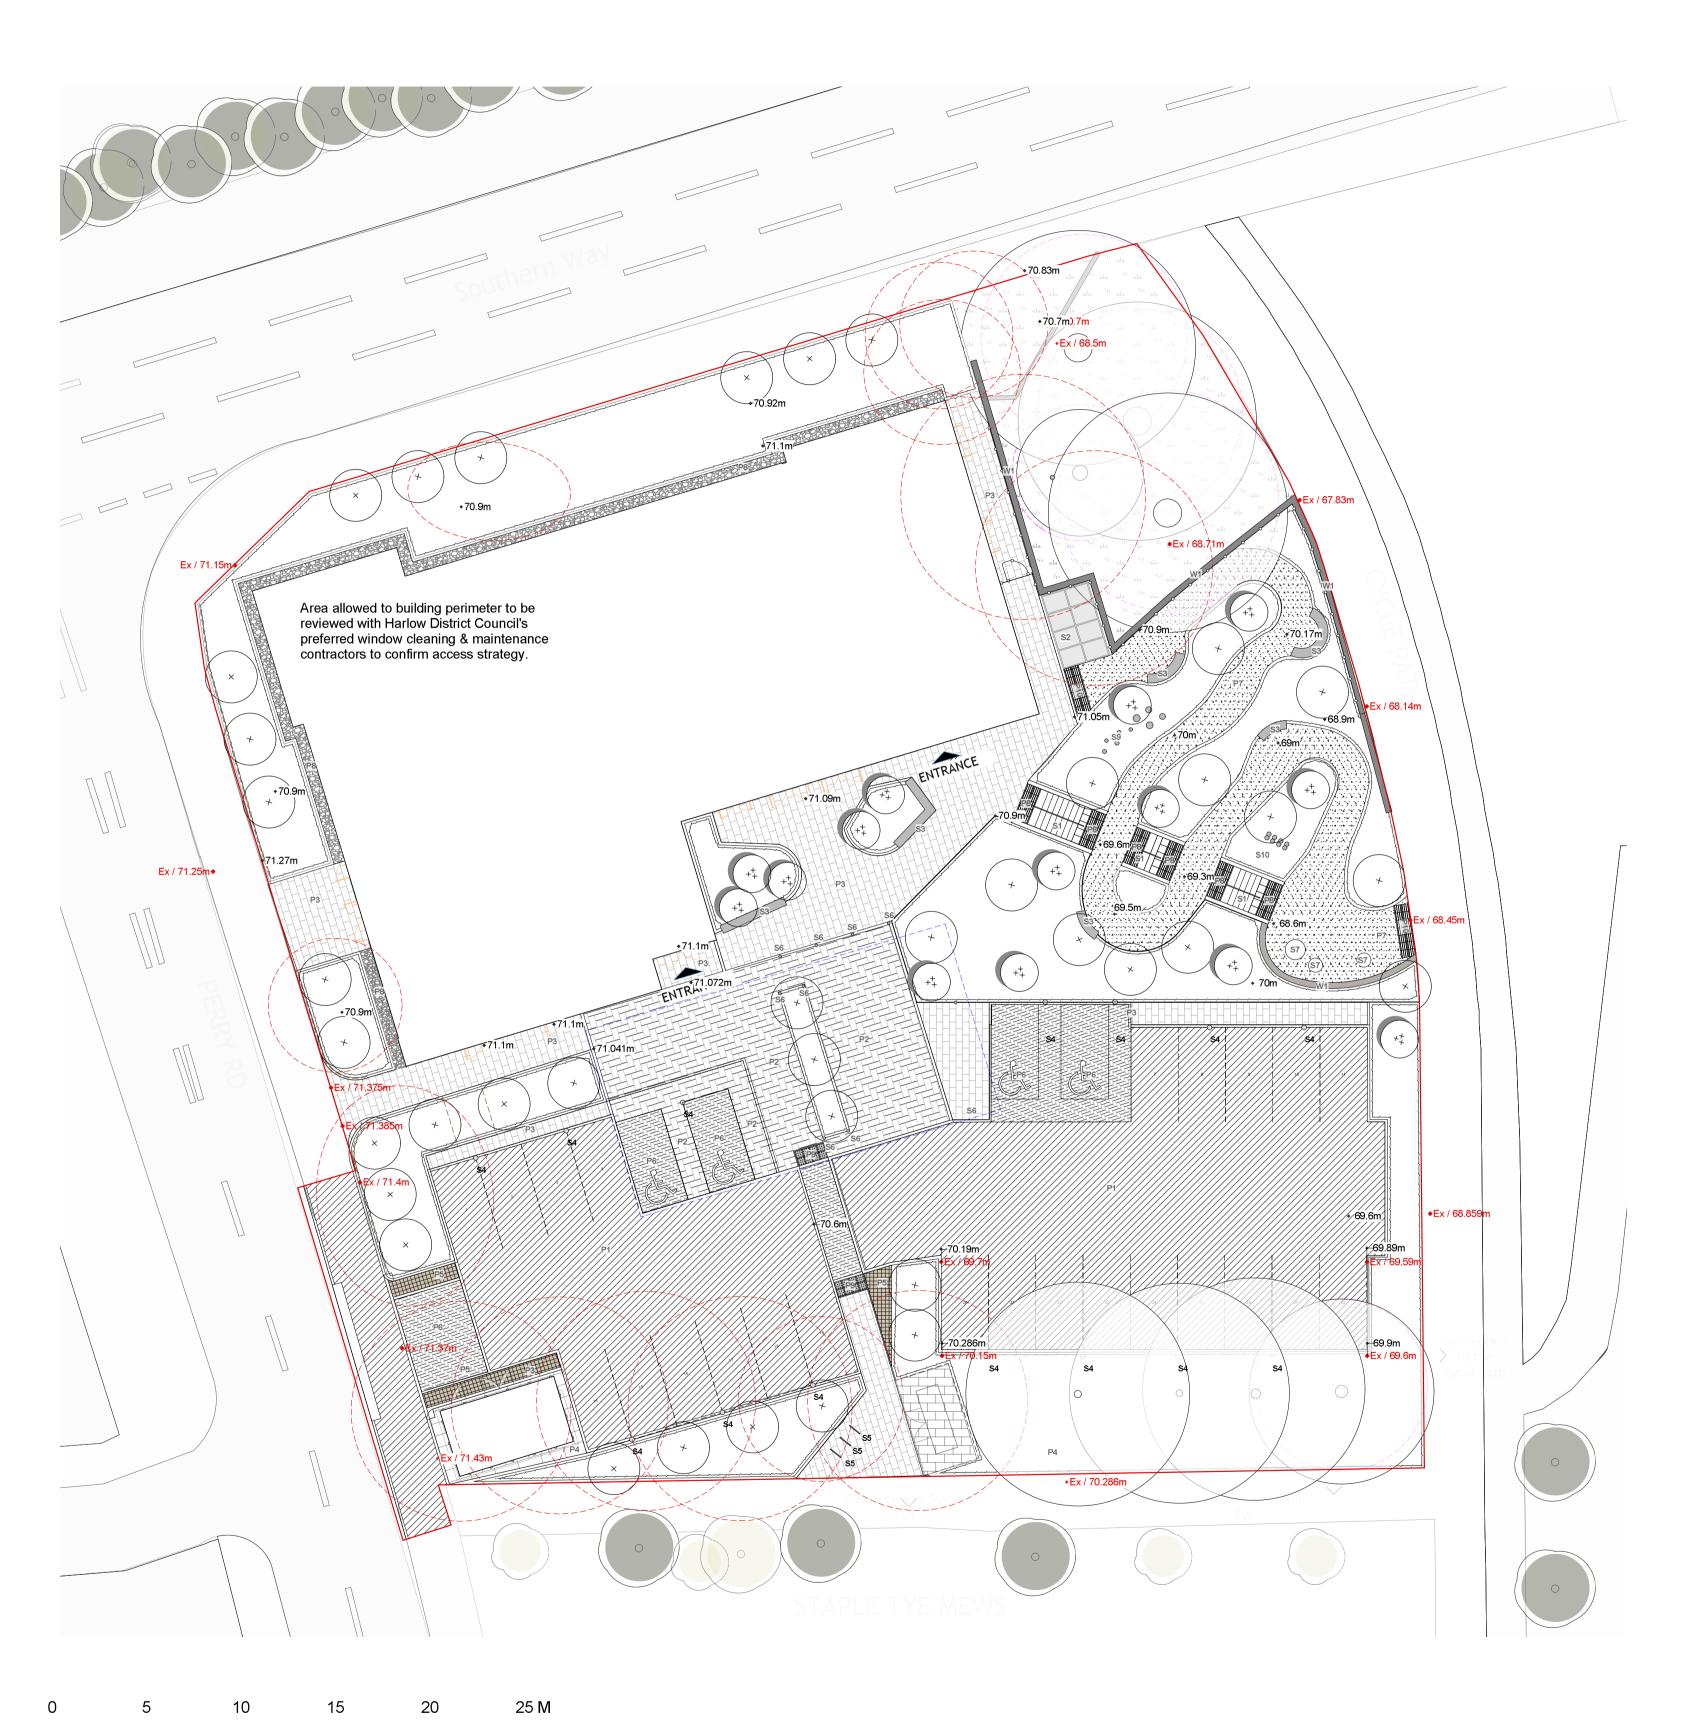

KEY CONT. **KEY** Fencing and Structures Planning Application Boundary Pedestrian Restraint System To W1 Wall. Colour to match building. To engineers' specification. See Note 12. Extent of Works Proposed Gates +12.345m Colour to mach building. See note 12. +Ex / 12.345m Existing Level Proposed Retaining Wall [Ref W1] Proposed Building Drainage Coordination Proposed Attenuation Tank Existing Tree Indicative Root Barrier TBC with service coordination Proposed Fowl Water Sewer and Manhole To drainage engineer's specification Existing Tree to be removed Proposed Surface Water Sewer and Manhole Existing Fowl Water Sewer and Manhole Planting Existing Surface Water Sewer and Manhole Proposed Tree Refer to Planting Plan Proposed Multi-stem Tree Amenity Planting Refer to Planting Plan Shrub Planting Refer to Planting Plan Paving Supplier: Contractor's Choice Product: To Engineer's Specification Colour: Black Vehicular Concrete Block Paving [Ref P2] Supplier: Tobermore or similar Product: Braemar or similar Colour: Arran Stone Laid in Herringbone bond Q24/XX P3 Colour: Arran Stone Concrete Flag Paving [Ref P4] Supplier: Tobermore or similar Product: Mayfair Flags or similar Colour: Silver Size: 600x400x50mm Laid in stretcher bond Colour: Silver Size: 100x100x80mm QXX/XXX Supplier: Tobermore or similar Product: Braemar or similar Colour: Arran Stone Size: 200x100x80mm Laid in herringbone pattern QXX/XXX --P8---Size: 400x400x50mm QXX/XXX

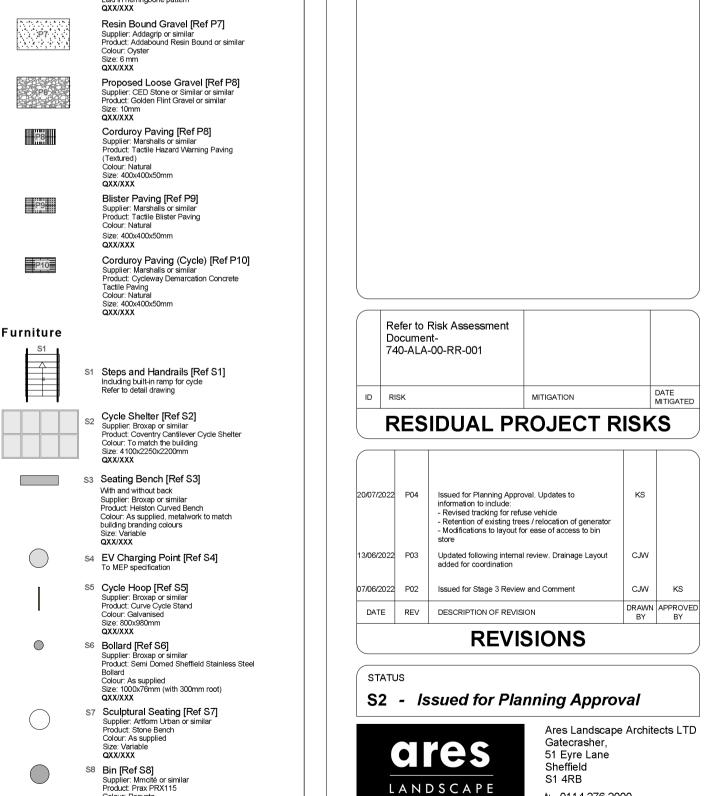

Note

1. Do not scale from this drawing 2. To be read in conjunction with 740-ALA-XX-XX-RR-L-001_ Risk

Assessment and Register

3. To be read in conjunction with all other Landscape Architect's

- 740-ALA-00-00-DR-L-0001_Landscape Illustrative Masterplan - 740-ALA-00-00-DR-L-0003_Planting Plan

- 740-ALA-00-00-DR-L-0004_Site Sections 4. To be read in conjunction with all other disciplines drawings

and specifications 5. All sub bases to retaining features, walls, paving build-ups to Project Engineers details. Formations levels are to be inspected

and approved by the Project Engineer 6. Drainage design, manhole cover positions & final levels to

becoordinated with Drainage Engineers

7. Lighting design, to be coordinated with M&E details 8. Landscape contractor is responsible for all area take offs. Areas and quantities are shown for information only

9. Any work to existing trees to be carried out by a suitability qualified Tree Surgeon.

10. Information shown outside red line is for illustrative purposes

packages:Architectural metalwork(including pedestrian restrain

only and are not part of this scope of works 11. Highway works by others 12. The following elements are intended to be specialist design

systems/gates/handrails) and all street furniture. Specialist contractor to carry out site measure and submit package for

architect's approval prior to procurement and manufacture. 13. Plant substitutions require approval from Landscape Architect

14. Cycle stands in accordance with TBC SPD3, to be 1.0m apart.

due to safeguarding and health and safety issues.

Woodland Understory Planting Refer to Planting Plan

Vehicular Asphalt Concrete [Ref P1]

Concrete Block Paving [Ref P3] Supplier: Tobermore or similar Product: Braemar or similar

Textured Concrete Setts [Ref P5] Supplier: Tobermore or similar Product: Fusion Setts or similar

Vehicular Concrete Block Paving [Ref P6]

Furniture

S8 Bin [Ref S8]
Supplier: Mmcité or similar
Product: Prax PRX115 Colour: Resysta Size: 930x250x350mm

S9 Stepping Logs [Ref S9]
Supplier: Pentagon Play or similar
Product: Robinia Constant Stepping Logs
Colour: As supplied
Size: 2200mm (I) x 400mm (w) x 650mm (h)
QXX/XXX

S10 Weaving Logs [Ref S10]
Supplier: Pentagon Play or similar
Product: Robinia Walk and Stretch (set of 8)
Colour: As supplied
Size: 1850mm (h)
QXX/XXX

PROJECT TITLE: Perry Road

ARCHITECTS

CLIENT:

McBains

DRAWING TITLE: Landscape General Arrangement

DRAWING SCALE: 1:200 CJW PAPER SIZE : APPROVED BY : A1

DRAWING NUMBER:

STATUS:

t: 0114 276 2000

w: ares.eu.com

e: hello@aresdesign.co.uk

ALA740 REVISION: P04

17/05/2022

ALA PROJECT CODE:

740-ALA-00-XX-DR-L-0002 S2




	1= .	- 15 1 1					
	Typology	Form / Description	Indicative Species Botanical Name	Indicative Species Common Name	Tree Girth/Dia. (cm) or Multistem Height(m)	Pot Size and Planting Density	Soil Requirements
ree A	Street Tree Planting	Street Tree	Prunus sargentii 'Rancho'	Sargent's Cherry	30-35cm		Tree pit volume should achieve 12-15cu m Site won soils to be used where available, to achieve: 450mm multipurpose topsoil to BS3882:2015 300mm multipurpose subsoil to BS6041:2015 150mm drainage to Engineers specifications [if needed depending in site conditions and percolation]
ree B	Car Park Tree Planting	Structural / Avenue Trees	Carpinus betulus 'Frans Fontaine' Tilia cordata	White Birch Small Leaved Lime	25-30cm 25-30cm		Tree pit volume should achieve 12-15cu m Site won soils to be used where available, to achieve - 450mm multipurpose topsoil to BS3882:2015 300mm multipurpose subsoil to BS6041:2015 150mm drainage to Engineers specifications [if needed depending in site conditions and percolation]
ree C	Multi-Stem Specimen Trees	Plaza Specimen Tree	Cercis Siliquastrum	Judas Tree	Multi-stem, 3.5-4m		Tree pit volume should achieve 12-15cu m Site won soils to be used where available, to achieve - 450mm multipurpose topsoil to BS3882:2015 300mm multipurpose subsoil to BS6041:2015 150mm drainage to Engineers specifications [if needed depending in site conditions and percolation]
ree C	Native Scrub Shrubs and Multi-stem Trees	Naturalistic Scrub Planting Trees	Carpinus betulus Crataegus monogyna Euonymus europaeus Prunus spinosa Viburnum opulus	Common Hornbeam Hawthorn Spindle Blackthorn Guelder Rose	Multi-stem, 2-2.5m Multi-stem, 2-2.5m Multi-stem, 1.5-2m Multi-stem, 2-2.5m Multi-stem, 1.5-2m		Tree pit volume should achieve 8-10cu m Site won soils to be used where available, to achieve - 450mm multipurpose topsoil to BS3882:2015 300mm multipurpose subsoil to BS6041:2015 150mm drainage to Engineers specifications [if needed depending in site conditions and percolation]
Aix A	Naturalistic Scrub Planting	Scrub planting ground cover mix with bulbs	Main body mix: Alchemilla molis Euonymous elatus 'Compactus' Euphorbia ceratocarpa Geranium macrorrhizum 'White-Ness' Miscanthus sinensis 'Morning Light' Molinia caerulea arundinacea 'Karl Foerster' Persicaria affinis 'Darjeeling Red' Rosmarinus officinalis 'Miss Jessopp's' Bulbs: Allium giganteum Allium sphaerocephalon Narcissus 'Jenny' Narcissus 'Thalia' Tulipa 'Queen of Night'	Main body mix: Lady's Mantle Winged spindle Sicily Spurge Geranium 'White-Ness' Chinese Silver Grass Purple Moor Grass 'Karl Foerster' Knotweed 'Darjeeling Red' Rosemary 'Miss Jessops Upright' Giant Ornamental Onion Round-headed Leek Daffodil 'Jenny' Daffodil 'Thalia' Tulip 'Queen of Night'		3L @ 9no. per m2 50no. per m2 50no. per m2 50no. per m2 50no. per m2	Site won soils to be used where available, to achieve - 450mm multipurpose topsoil to BS3882:2015. If required to make up levels or where subsoils are not present, 300mm multipurpose subsoil to BS6041:2015.
Aix B	Swathe Planting	Swathes of perennial planting with bulbs and spot planted emergent specimens.	Main body mix: Ajuga reptans 'Atropurpurea' Geranium macrorrhizum 'Album' Hakonechloa macra 'Aureola' Hebe rakaiensis Molinia caerulea arundinacea 'Karl Foerster' Liriope muscari Liriope muscari 'Monroe White' Luzula nivea Stachys byzantina 'Silver Carpet' Stipa tenuissima Bulbs: Allium giganteum Allium sphaerocephalon Narcissus 'Jenny' Narcissus 'Thalia' Tulipa 'Queen of Night' Emergent / Specimen Species: Salvia x sylvestris 'Mainacht' Sedum 'Herbstfreude' Lavandula angustifolia Miscanthus sinensis 'Yakushima Dwarf'	Bronze Bugle Balkan Cranesbill 'Album' Golden Hakone Grass Rakai Hebe Purple Moor Grass 'Karl Foerster' Big Blue Lilyturf Big Blue Lilyturf 'Monroe White' Snowy Wood-rush Lambs' Ears 'Silver Carpet' Mexican Feather Grass Giant Ornamental Onion Round-headed Leek Daffodil 'Jenny' Daffodil 'Thalia' Tulip 'Queen of Night' Sage 'Mainacht' Stonecrop 'Herbstfreude' True Lavender Eulalia 'Yakushima Dwarf'		3L @ 9no. per m2 3L @ 3no. per m2	Site won soils to be used where available, to achieve - 450mm multipurpose topsoil to BS3882:2015. If required to make up levels or where subsoils are not present, 300mm multipurpose subsoil to BS6041:2015.
eeding	Woodland Understory Seed Mix	A mixture of species which prefer or tolerate semi shade conditions.	Alliaria petiolata Allium ursinum Arctium minus Campanula trachelium Chaerophyllum temulum Digitalis purpurea Filipendula ulmaria Galium album Geum urbanum Hyacinthoides non-scripta Iris foetidissima Prunella vulgaris Silene dioica Torilis japonica Vicia cracca	Garlic Mustard Ramsons Lesser Burdock Nettle-leaved Bellflower Rough Chervil Foxglove Meadowsweet Hedge Bedstraw Wood Avens Bluebell Gladdon Selfheal Red Campion Upright Hedge-parsley Tufted Vetch		Seed/plug plan to supplier's recommendation	Existing soil profile to be retained with additional 75mm multipurpose topsoil to BS3882:2015. Site won soils to be used where available.

Note

- 1. Do not scale from this drawing
- 2. To be read in conjunction with 740-ALA-XX-XX-RR-L-001_ Risk Assessment and Register
- 3. To be read in conjunction with all other Landscape Architect's drawings:
- 740-ALA-00-00-DR-L-0001_Landscape Illustrative Masterplan - 740-ALA-00-00-DR-L-0003_Planting Plan
- 740-ALA-00-00-DR-L-0004_Site Sections
- 4. To be read in conjunction with all other disciplines drawings
- and specifications
- 5. All sub bases to retaining features, walls, paving build-ups to Project Engineers details. Formations levels are to be inspected
- and approved by the Project Engineer 6. Drainage design, manhole cover positions & final levels to
- becoordinated with Drainage Engineers
- 7. Lighting design, to be coordinated with M&E details
- 8. Landscape contractor is responsible for all area take offs. Areas
- and quantities are shown for information only
- 9. Any work to existing trees to be carried out by a suitability
- qualified Tree Surgeon.
- 10. Information shown outside red line is for illustrative purposes
- only and are not part of this scope of works
- 11. Highway works by others
- 12. The following elements are intended to be specialist design
- packages:Architectural metalwork(including pedestrian restrain
- systems/gates/handrails) and all street furniture. Specialist
- contractor to carry out site measure and submit package for
- architect's approval prior to procurement and manufacture.
- 13. Plant substitutions require approval from Landscape Architect due to safeguarding and health and safety issues.
- 14. Cycle stands in accordance with TBC SPD3, to be 1.0m apart.



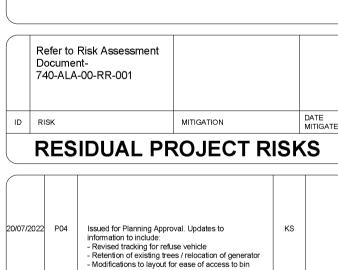

			REVISIONS		
	DATE	REV	DESCRIPTION OF REVISION	DRAWN BY	APPROVED BY
08	3/06/2022	P02	Issued for Stage 3 Review and Comment	CJW	KS
13	3/06/2022	P03	Updated following internal review	CJW	
20	0/07/2022	P04	Issued for Planning Approval. Updates to information to include: - Revised tracking for refuse vehicle - Retention of existing trees / relocation of generator - Modifications to layout for ease of access to bin store	KS	

KEVISIONS

S2 - Issued for Planning Approval



Gatecrasher, 51 Eyre Lane Sheffield S1 4RB t: 0114 276 2000 e: hello@aresdesign.co.uk w: ares.eu.com

McBains

PROJECT TITLE :

Perry Road

1:200

DRAWING TITLE :

Planting Plan

PAPER SIZE : APPROVED BY: A1

DRAWING NUMBER :

STATUS: REVISION:

17/05/2022

ALA740

ALA PROJECT CODE:


740-ALA-00-XX-DR-L-0003



1 Proposed North Elevation 1: 100



Proposed East Elevation

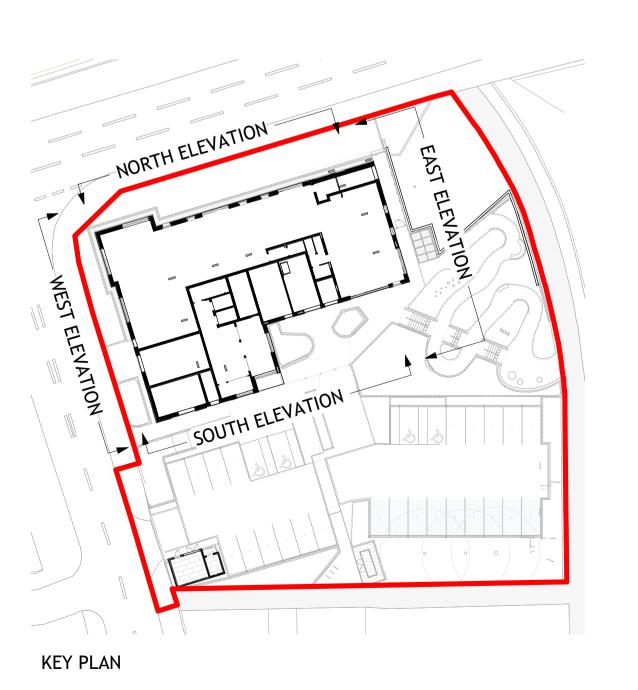

Contractors must verify all dimensions on site before commencing any work on shop drawings Do not scale from this drawing McBains Ltd copyright

BIM Transmittal Disclaimer

McBains Ltd makes no express or implied warranties with respect to the character, function, or capabilities of the data (inclusive of 3rd party data incorporated within), or the suitability of the data for any particular purpose beyond those originally intended by McBains Ltd. please refer to our standard terms and conditions for further details.



KEY:

- BUFF FACING BRICKWORK TYPE 01
- GREY/BLACK FACING BRICKWORK TYPE 02
- SOLDIER BRICKWORK COURSE
- VERTICAL PROFILED PPC ALUMINIUM CLADDING
- PPC ALUMINIUM BRISE SOLIEL
- PPC METAL BALUSTRADE AND BALCONY
- PPC ALUMINIUM FRAMED DOUBLE GLAZED WINDOWS
- PPC ALUMINIUM FRAMED CURTAIN WALLING & WINDOWS
- PPC METAL DOORS WITH LOUVRED PANEL ABOVE
- PPC ALUMINIUM CANOPY WITH SIGNAGE
- PPC ALUMINIUM LOUVRED ACOUSTIC SCREEN
- PPC ALUMINIUM THROUGH WALL POST-BOXES
- PPC ALUMINIUM LOUVRES
- PPC ALUMINIUM FRAMED CURTAIN WALLING & **ENTRANCE DOORS**
- PPC ALUMINIUM SPANDREL PANEL
- PPC ALUMINIUM PARAPET CAPPING
- PPC METAL SOLAR/PRIVACY SCREENING
- PPC METAL VIDEO ENTRY PANEL
- PPC METAL DRY RISER INLET PANEL
- BUILDING/ROAD SIGNAGE
- PPC ALUMINIUM FRAMED DOUBLE GLAZED SLIDING

P010	Issued for Planni	ng		21.04.23		
P09	Issued for Inform	ssued for Information 31.03.23				
C08	Stage 2 Issue Am	nended		07.02.23		
C07	Stage 2 Issue	Stage 2 Issue 20.01.23				
P06	Stage 3 Issue	Stage 3 Issue 13.06.22				
C05	Issued for Planning 25.05.22					
P04	Issued for Coord	Issued for Coordination 18.05.22				
P03	Issued for Coord	ination		12.05.22		
P02	Issued for Coordination - Window Types Updated 03.05.22					
P01	Issued for Coordination			29.04.22		
Revision		Amendment	Date			
	LP	CD	MI	ЕРВ		
	Drawn by	Reviewed by	Approved by			
6	0715A	07/02/2023	As indicated @ A1			
	MCB Number	Date Created	Scale @ A1			

WCBains

5th Fl, 26 Finsbury Square London EC2A 1DS +44 (0)20 7786 7900 mcbains.co.uk

HARLOW DISTRICT COUNCIL

PERRY ROAD, HARLOW ESSEX, CM18 7LT

Drawing Title

PROPOSED ELEVATIONS SHEET 1 OF 2



HARPR - MCB - XX - ZZ - DR - A - 0130 | S4 - P010



2 Proposed South Elevation






Proposed West Elevation

Contractors must verify all dimensions on site before commencing any work on shop drawings Do not scale from this drawing McBains Ltd copyright

BIM Transmittal Disclaimer

McBains Ltd makes no express or implied warranties with respect to the character, function, or capabilities of the data (inclusive of 3rd party data incorporated within), or the suitability of the data for any particular purpose beyond those originally intended by McBains Ltd. please refer to our standard terms and conditions for further details.

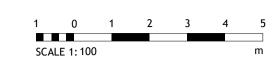

KEY:

- BUFF FACING BRICKWORK TYPE 01
- GREY/BLACK FACING BRICKWORK TYPE 02
- SOLDIER BRICKWORK COURSE
- VERTICAL PROFILED PPC ALUMINIUM CLADDING
- PPC ALUMINIUM BRISE SOLIEL
- PPC METAL BALUSTRADE AND BALCONY
- PPC ALUMINIUM FRAMED DOUBLE GLAZED WINDOWS
- PPC ALUMINIUM FRAMED CURTAIN WALLING & **WINDOWS**
- PPC METAL DOORS WITH LOUVRED PANEL ABOVE
- PPC ALUMINIUM CANOPY WITH SIGNAGE
- PPC ALUMINIUM LOUVRED ACOUSTIC SCREEN
- PPC ALUMINIUM THROUGH WALL POST-BOXES
- PPC ALUMINIUM LOUVRES
- PPC ALUMINIUM FRAMED CURTAIN WALLING & **ENTRANCE DOORS**
- PPC ALUMINIUM SPANDREL PANEL
- PPC ALUMINIUM PARAPET CAPPING
- PPC METAL SOLAR/PRIVACY SCREENING
- PPC METAL VIDEO ENTRY PANEL
- PPC METAL DRY RISER INLET PANEL
- BUILDING/ROAD SIGNAGE
- PPC ALUMINIUM FRAMED DOUBLE GLAZED SLIDING

P01 Issued for Coordination			acca	29.04.22		
P02 Issued for Coordination - Window Types Updated			dated	03.05.22		
P03 Issued for Coordination				12.05.22		
P04		18.05.22				
C05	Issued for Planni		25.05.22			
P06	Stage 3 Issue		13.06.22			
C07	Stage 2 Issue			20.01.23		
C08	Stage 2 Issue Am	nended		07.02.23		
P09	Issued for Inform	Issued for Information				
P010	Issued for Planni		21.04.23			
D040						

Drawn by	Reviewed by	Approved by
60715A	07/02/2023	As indicated @ A1
MCB Number	Date Created	Scale @ A1

5th Fl, 26 Finsbury Square London EC2A 1DS +44 (0)20 7786 7900 mcbains.co.uk


HARLOW DISTRICT COUNCIL

PERRY ROAD, HARLOW ESSEX, CM18 7LT

Drawing Title

PROPOSED ELEVATIONS SHEET 2 0F 2


HARPR - MCB - XX - ZZ - DR - A - 0131

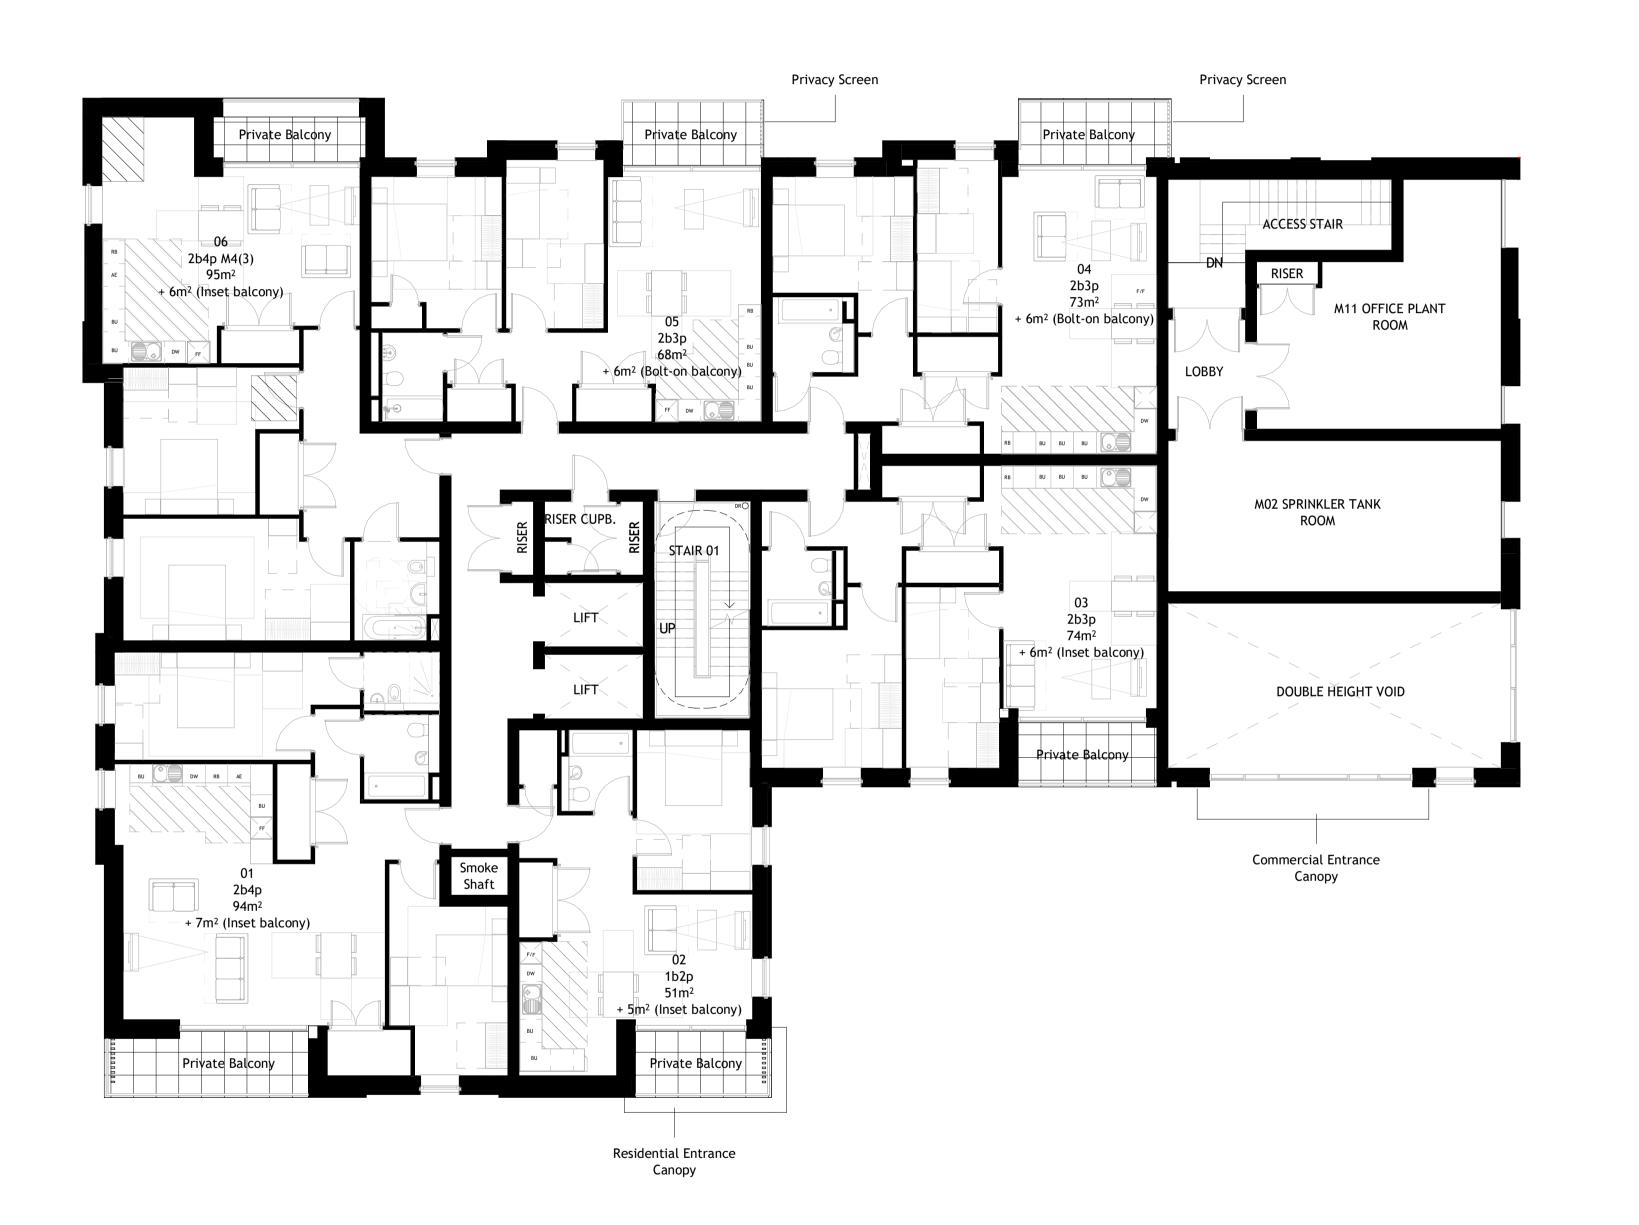

BIM Transmittal Disclaimer

McBains Ltd makes no express or implied warranties with respect to the character, function, or capabilities of the data (inclusive of 3rd party data incorporated within), or the suitability of the data for any particular purpose beyond those originally intended by McBains Ltd. please refer to our standard terms and conditions for further details.



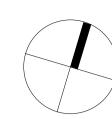

P010	Issued for Planning	21.04.23
P09	Issued for Information	31.03.23
P08	Issued for Information	20.03.23
C07	Stage 2 Issue	20.01.23
P06	Issued for Information	21.12.22
P05	Stage 3 Issue	13.06.22
C04	Issued for Planning	25.05.22
P03	Issued for Coordination	18.05.22
P02	Issued for Coordination	29.04.22
P01	Issued for Coordination	01.04.22
Revision	Amendment	Date

	LP	CD	MEPB
	rawn by	Reviewed by	Approved by
60)715A	DEC 2021	1 : 100 @ A1
MC	CB Number	Date Created	Scale @ A1




5th Fl, 26 Finsbury Square London EC2A 1DS +44 (0)20 7786 7900 mcbains.co.uk

HARLOW DISTRICT COUNCIL

PERRY ROAD, HARLOW ESSEX, CM18 7LT


Drawing Title Proposed - First Floor Plan


HARPR - MCB - XX - 01 - DR - A - 0300 | S4 - P010

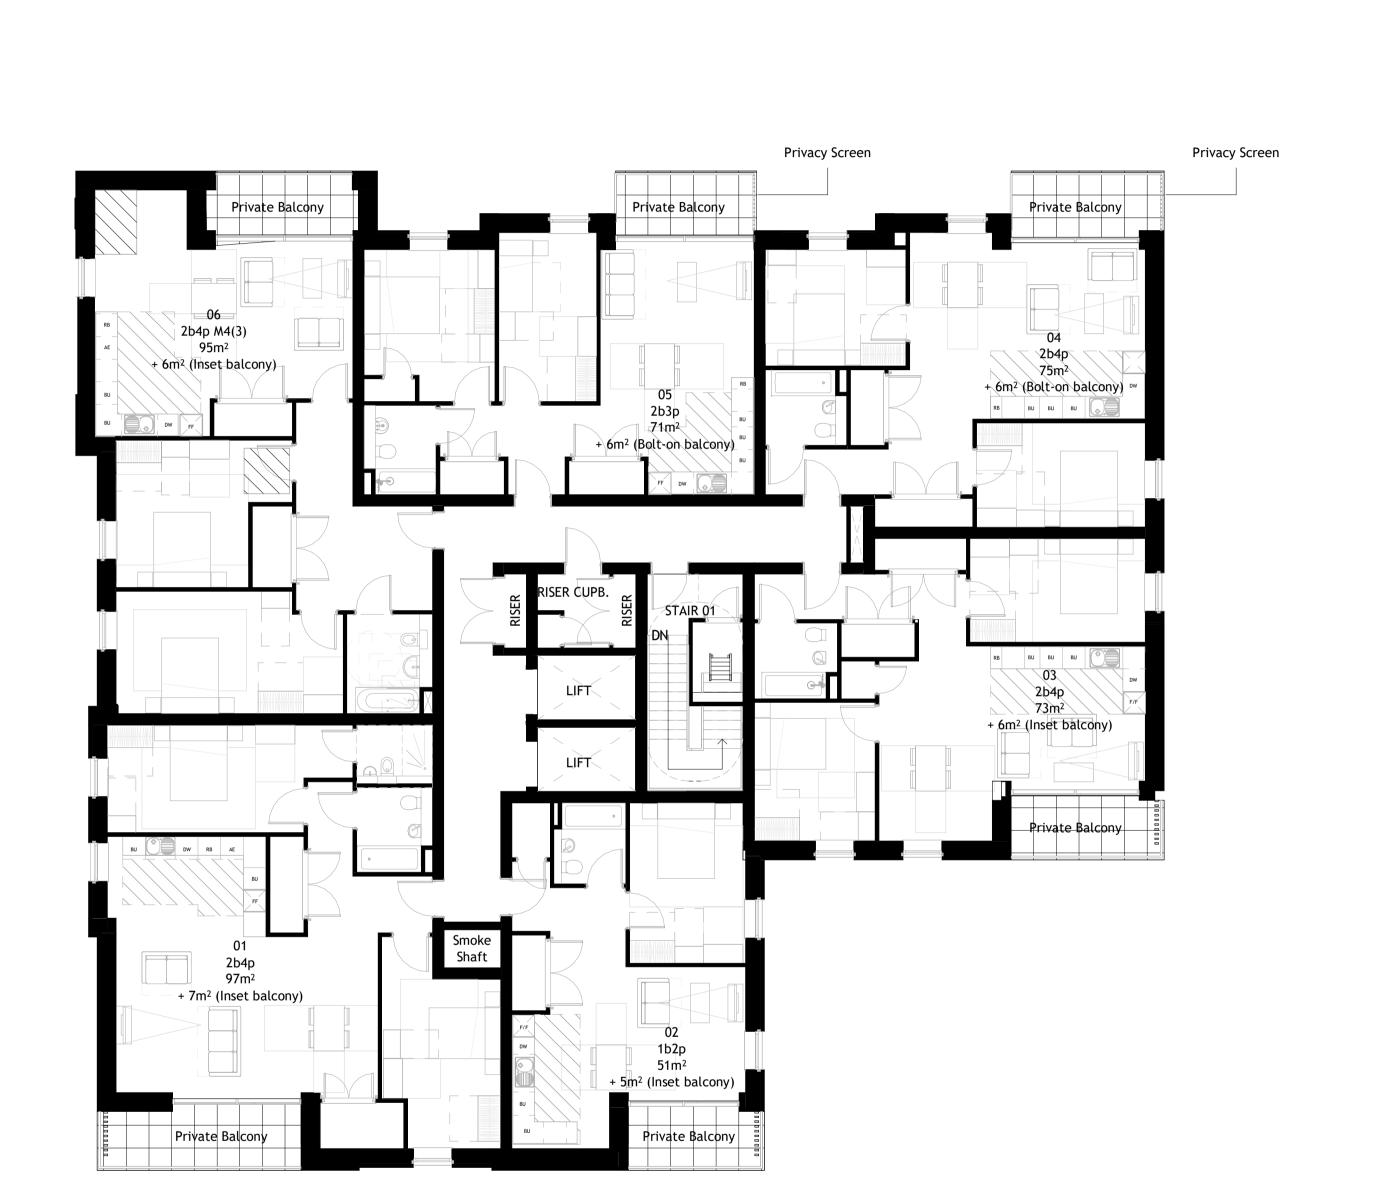

BIM Transmittal Disclaimer

McBains Ltd makes no express or implied warranties with respect to the character, function, or capabilities of the data (inclusive of 3rd party data incorporated within), or the suitability of the data for any particular purpose beyond those originally intended by McBains Ltd. please refer to our standard terms and conditions for further details.

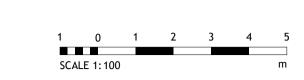

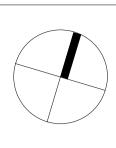

sion	ns	Amendment		Date PR	
	Issued for Information 21.12.2				
	Stage 2 Issue	20.01.23			
	Issued for Inform	31.03.23			
	Issued for Planni	21.04.23			

DS	CD	МЕРВ
Drawn by	Reviewed by	Approved by
60715A	12/19/22	1:100 @ A1
MCB Number	Date Created	Scale @ A1



5th Fl, 26 Finsbury Square London EC2A 1DS +44 (0)20 7786 7900 mcbains.co.uk

HARLOW DISTRICT COUNCIL

PERRY ROAD, HARLOW ESSEX, CM18 7LT

Drawing Title PROPOSED - FOURTH FLOOR PLAN


HARPR - MCB - XX - 04 - DR - A - 0300 S4 - P04





BIM Transmittal Disclaimer

McBains Ltd makes no express or implied warranties with respect to the character, function, or capabilities of the data (inclusive of 3rd party data incorporated within), or the suitability of the data for any particular purpose beyond those originally intended by McBains Ltd. please refer to our standard terms and conditions for further details.

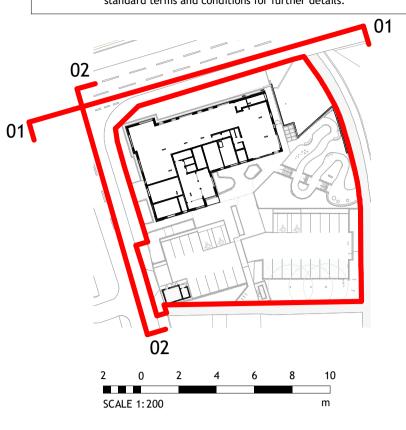

Proposed Site Elevation 01
1:200



Proposed Site Elevation 02
1:200

P03 Issued for Planning
P02 Stage 3 Issue
C01 Issued for Planning
Revision CD 60715A 05/04/22 As indicated @ A1 MCB Number Date Created 5th Fl, 26 Finsbury Square London EC2A 1DS +44 (0)20 7786 7900 mcbains.co.uk HARLOW DISTRICT COUNCIL PERRY ROAD, HARLOW ESSEX, CM18 7LT

Drawing Title

PROPOSED GA SITE ELEVATIONS


21.04.23 13.06.22

25.05.22 Date

MEPB


Scale @ A1

HARPR - MCB - XX - ZZ - DR - A - 0133 | S4 - P03

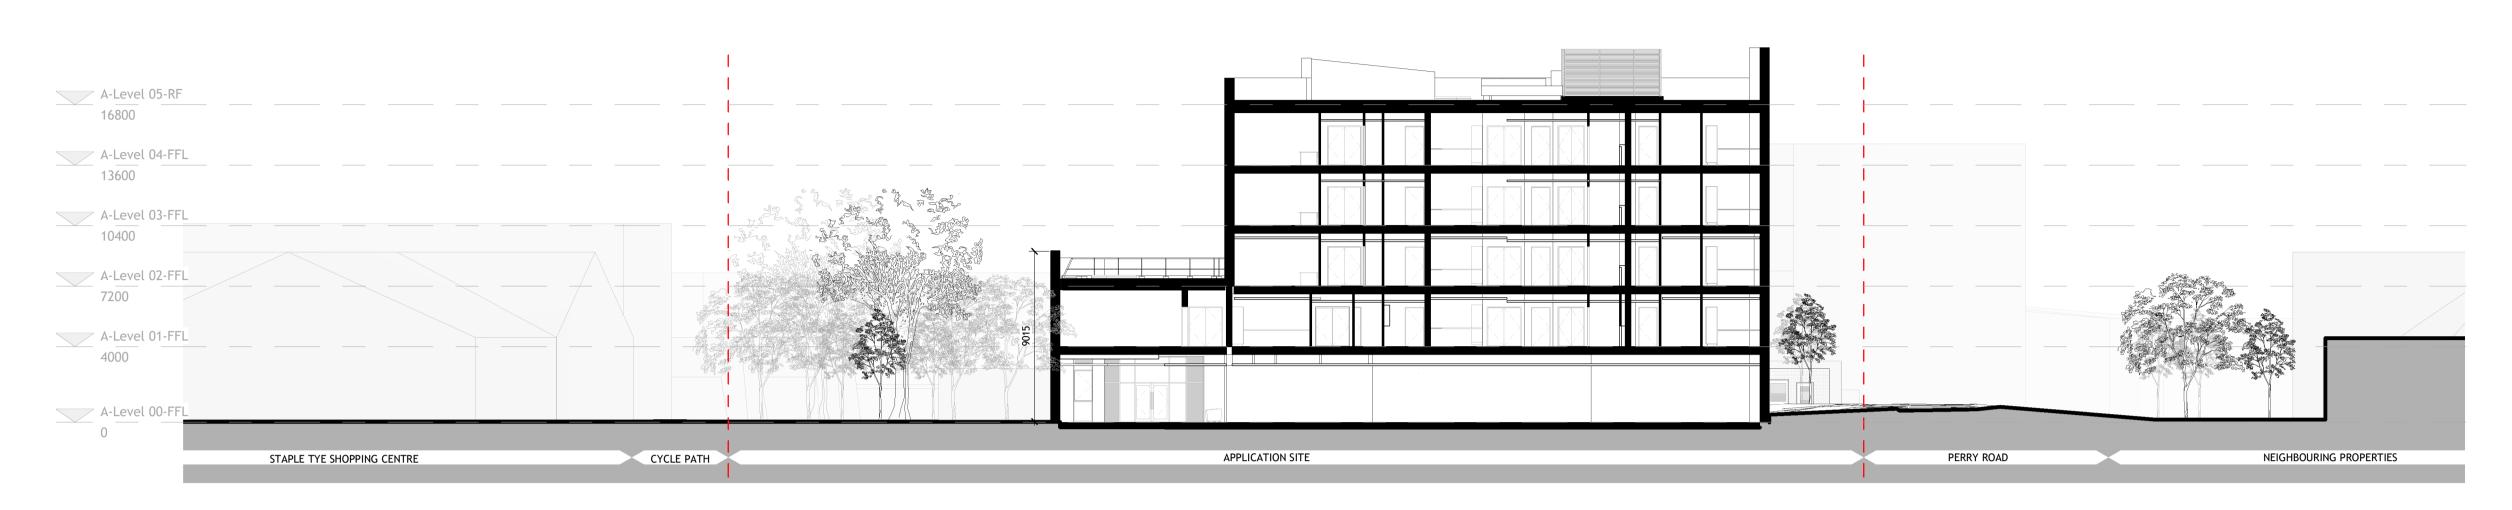


BIM Transmittal Disclaimer

McBains Ltd makes no express or implied warranties with respect to the character, function, or capabilities of the data (inclusive of 3rd party data incorporated within), or the suitability of the data for any particular purpose beyond those originally intended by McBains Ltd. please refer to our standard terms and conditions for further details.

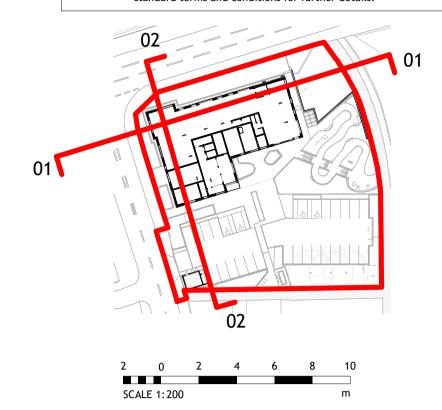

Proposed Site Section 01
1:200

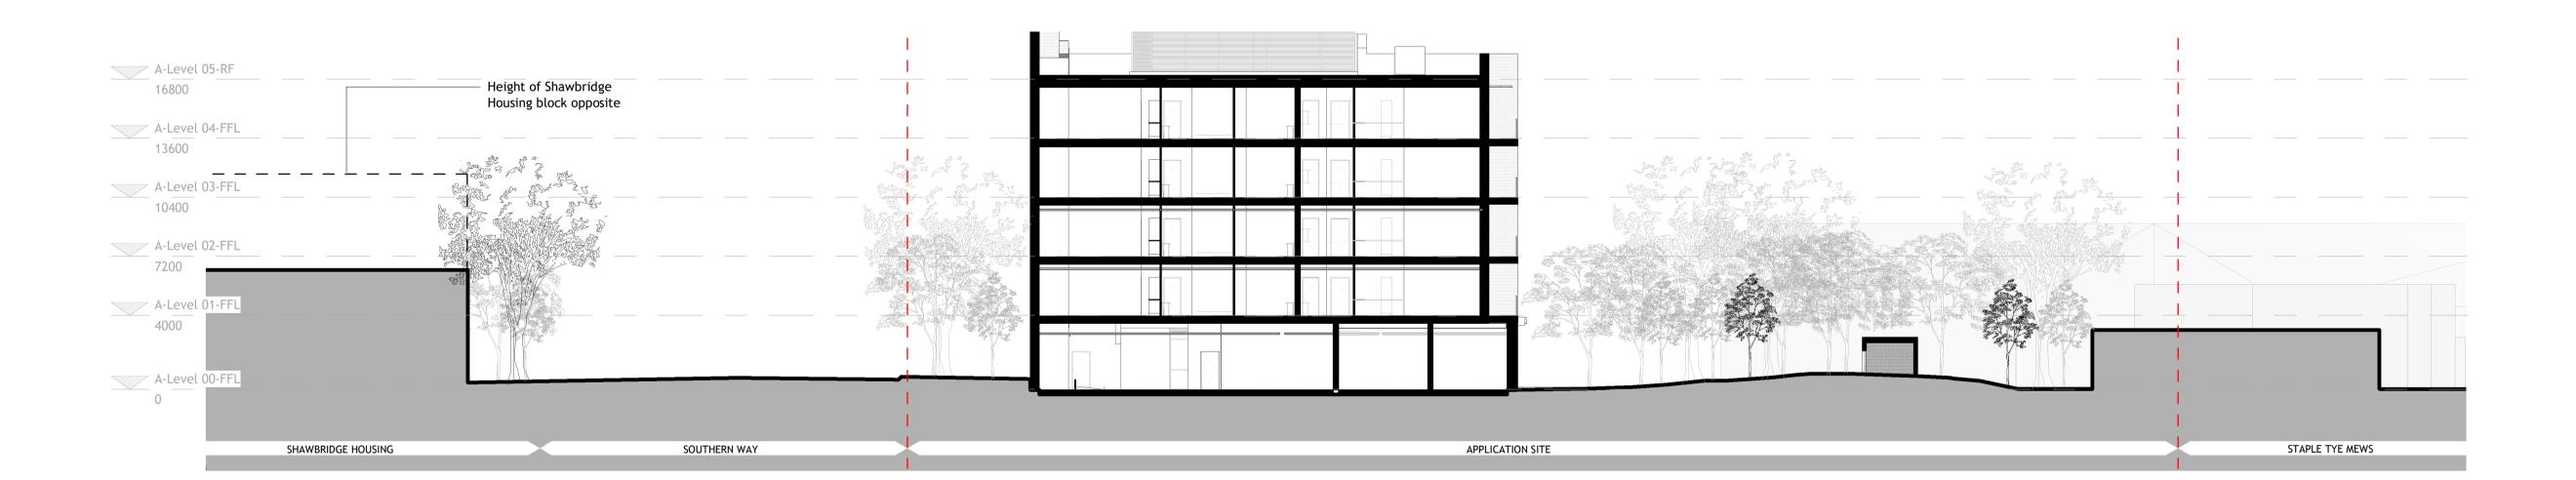


Proposed Site Section 02
1:200


21.04.23 07.02.23 13.06.22 Issued for Planning CO3 Stage 2 Issue Amended
PO2 Stage 3 Issue
CO1 Issued for Planning
Revision 25.05.22 Date LP CD MEPB Drawn by 60715A 07/02/2023 As indicated @ A1 MCB Number Date Created Scale @ A1 5th Fl, 26 Finsbury Square London EC2A 1DS +44 (0)20 7786 7900 mcbains.co.uk HARLOW DISTRICT COUNCIL Project PERRY ROAD, HARLOW ESSEX, CM18 7LT **Drawing Title** Proposed GA Site Sections

HARPR - MCB - XX - ZZ - DR - A - 0134 | S4 - P04

BIM Transmittal Disclaimer

McBains Ltd makes no express or implied warranties with respect to the character, function, or capabilities of the data (inclusive of 3rd party data incorporated within), or the suitability of the data for any particular purpose beyond those originally intended by McBains Ltd. please refer to our standard terms and conditions for further details.

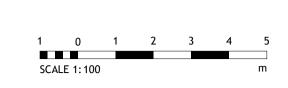

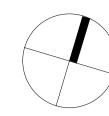

P011	Issued for Planning Issued for Information	31.03.23
P010	Issued for Information	20.03.23
C09	Stage 2 Issue	20.01.23
P08	Issued for Information	21.12.22
P07	Stage 3 Issue	13.06.22
P06	Issued for Information	08.06.22
C05	Issued for Planning	25.05.22
P04	Issued for Coordination	18.05.22
P03	Issued for Information	12.05.22
P02	Issued for Coordination	29.04.22
P01	Issued for Coordination	01.04.22
Revision	Amendment	Date

LP	CD	MEPB
Drawn by	Reviewed by	Approved by
60715A	DEC 2021	1:100 @ A1
MCB Number	Date Created	Scale @ A1

McBains

McBains Ltd
5th Fl, 26 Finsbury Square London EC2A 1DS
+44 (0)20 7786 7900 mcbains.co.uk

Client HARLOW DISTRICT COUNCIL


Project
PERRY ROAD, HARLOW
ESSEX, CM18 7LT

Drawing Title Proposed - Ground Floor Plan

ARCHITECTURE

Drawing / Document Reference

HARPR - MCB - XX - 00 - DR - A - 0300 S4 - P012

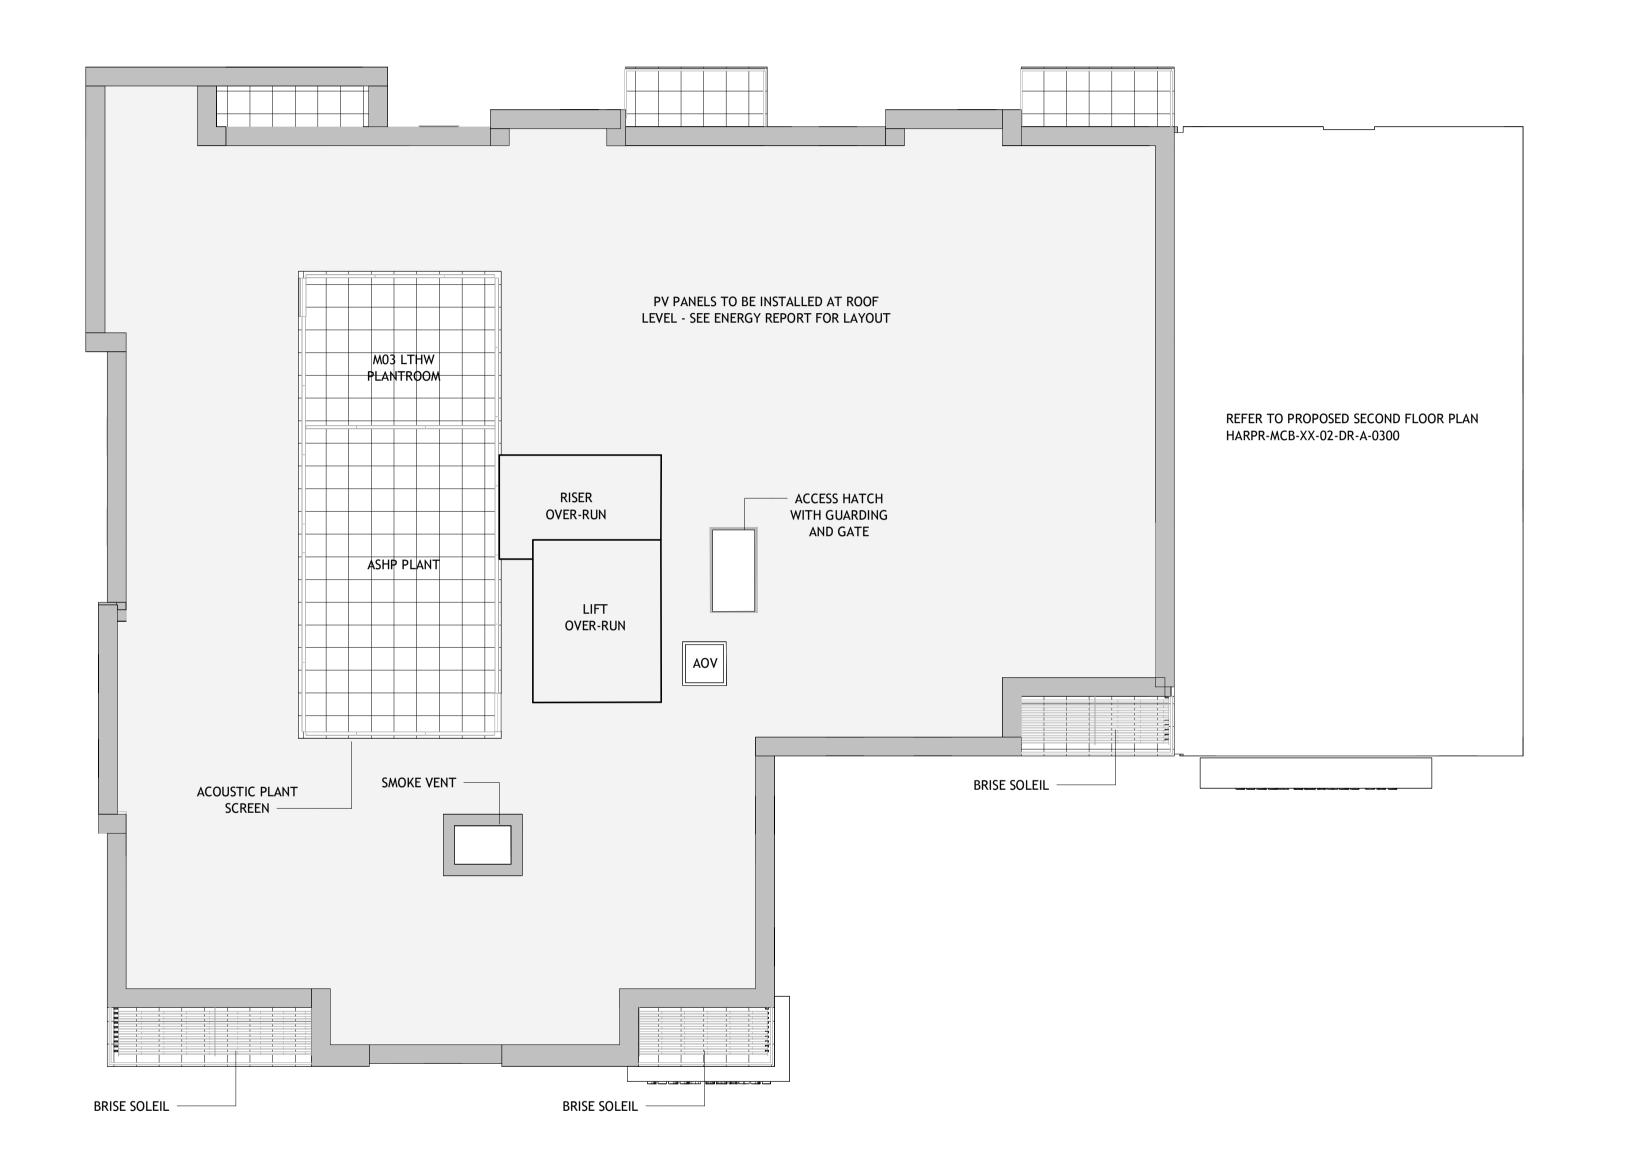


on shop drawings Do not scale from this drawing

McBains Ltd copyright

BIM Transmittal Disclaimer

McBains Ltd makes no express or implied warranties with respect to the character, function, or capabilities of the data (inclusive of 3rd party data incorporated within), or the suitability of the data for any particular purpose beyond those originally intended by McBains Ltd. please refer to our standard terms and conditions for further details.



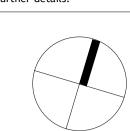

21.04.23 Issued for Planning 31.03.23 Issued for Information 20.01.23 Stage 2 Issue Issued for Information 21.12.22 Stage 3 Issue 13.06.22 25.05.22 Issued for Planning 18.05.22 Issued for Coordination P02 Issued for Coordination 29.04.22 P01 Issued for Coordination 01.04.22 Date

LP	CD	МЕРВ
Drawn by	Reviewed by	Approved by
60715A	03/03/22	1 : 100 @ A1
MCB Number	Date Created	Scale @ A1



McBains Ltd

5th Fl, 26 Finsbury Square London EC2A 1DS
+44 (0)20 7786 7900 mcbains.co.uk

Client
HARLOW DISTRICT COUNCIL

Project
PERRY ROAD, HARLOW
ESSEX, CM18 7LT

Drawing Title

PROPOSED - ROOF PLAN

ARCHITECTURE

Drawing / Document Referen

HARPR - MCB - XX - RF - DR - A - 0300 S4 - P09


Proposed - Roof Plan
1:100



BIM Transmittal Disclaimer

McBains Ltd makes no express or implied warranties with respect to the character, function, or capabilities of the data (inclusive of 3rd party data incorporated within), or the suitability of the data for any particular purpose beyond those originally intended by McBains Ltd. please refer to our standard terms and conditions for further details.



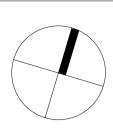

P09	Issued for Planning	21.04.23
P08	Issued for Information	31.03.23
C07	Stage 2 Issue	20.01.23
P06	Issued for Information	21.12.22
P05	Stage 3 Issue	13.06.22
C04	Issued for Planning	25.05.22
P03	Issued for Coordination	18.05.22
P02	Issued for Coordination	29.04.22
P01	Issued for Coordination	01.04.22
Revision	Amendment	Date

LP	CD	MEPB
Drawn by	Reviewed by	Approved by
60715A	Jan 2022	1 : 100 @ A1
MCB Number	Date Created	Scale @ A1


5th Fl, 26 Finsbury Square London EC2A 1DS +44 (0)20 7786 7900 mcbains.co.uk

HARLOW DISTRICT COUNCIL

PERRY ROAD, HARLOW ESSEX, CM18 7LT

Drawing Title Proposed - Second Floor Plan

HARPR - MCB - XX - 02 - DR - A - 0300 S4 - P09

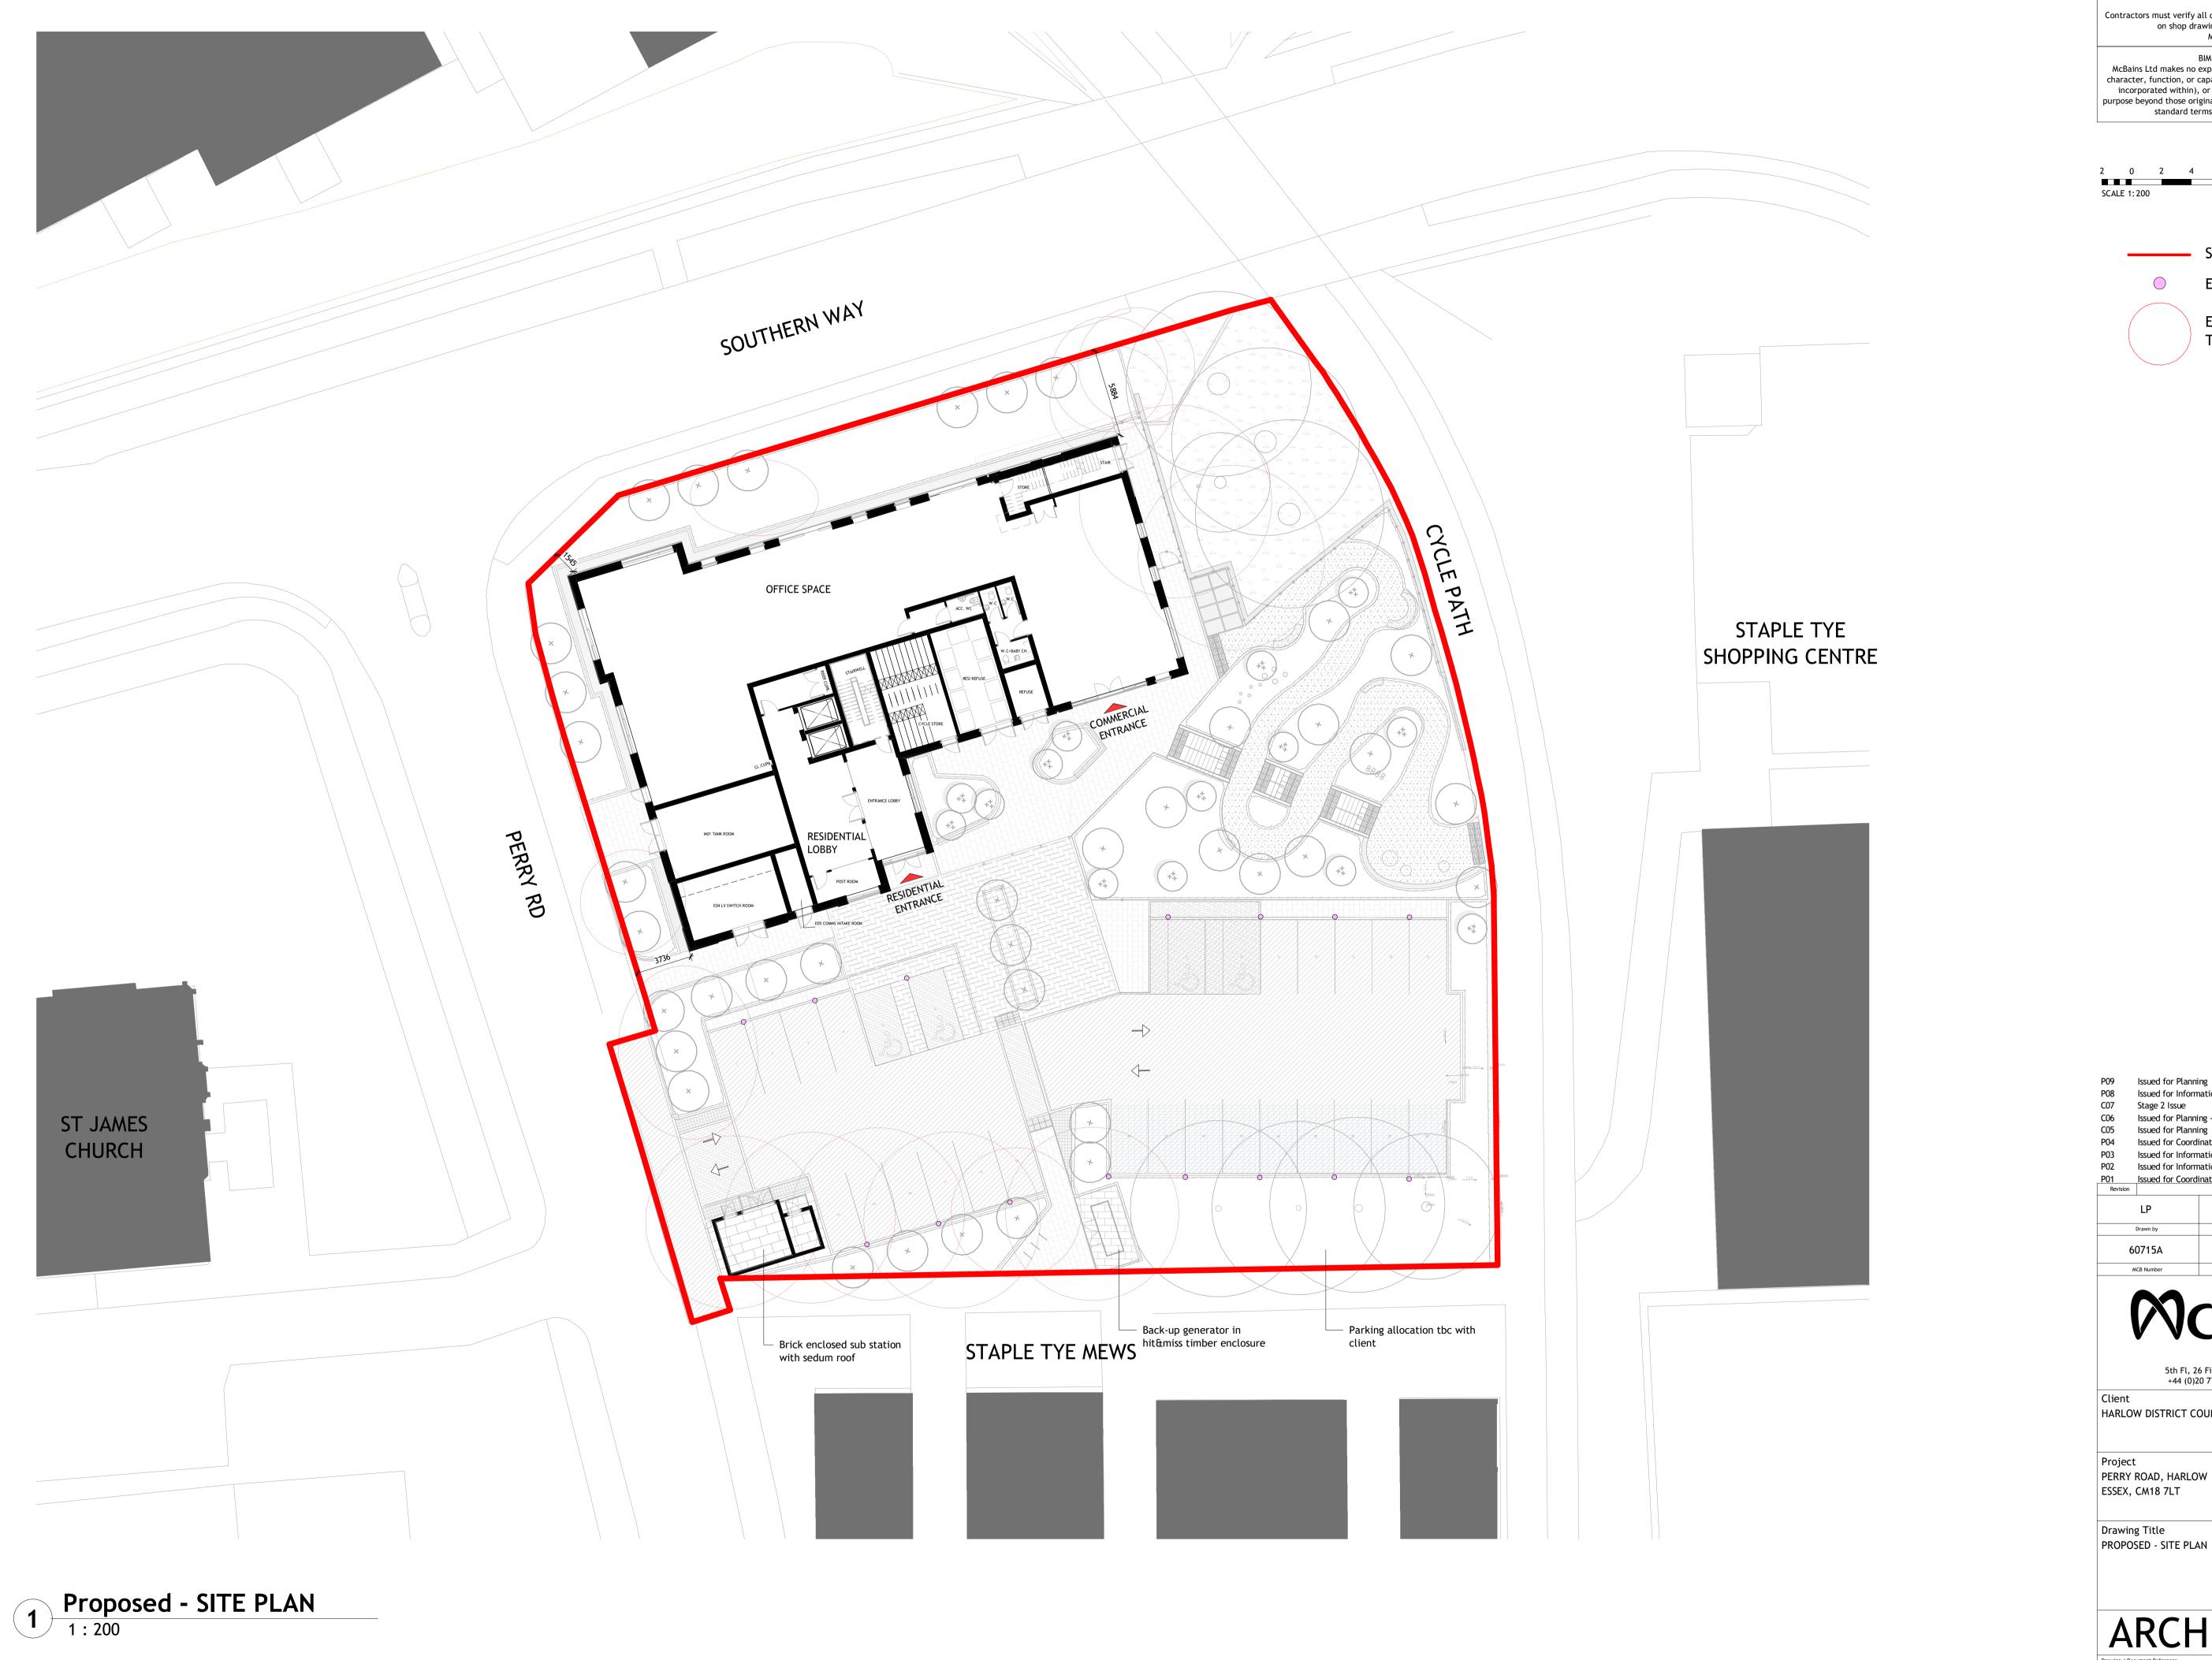

BIM Transmittal Disclaimer

McBains Ltd makes no express or implied warranties with respect to the character, function, or capabilities of the data (inclusive of 3rd party data incorporated within), or the suitability of the data for any particular purpose beyond those originally intended by McBains Ltd. please refer to our standard terms and conditions for further details.



SITE BOUNDARY

EV CHARGING POINT

EXISTING TREES TO BE REMOVED


P09	Issued for Planning	g		21.04.23
P08	Issued for Informa	tion		31.03.23
C07	Stage 2 Issue			20.01.23
C06	Issued for Planning	g - Updated Landscape Info	ormation	22.07.22
C05	Issued for Planning	g		25.05.22
P04	Issued for Coordin	ation		18.05.22
P03	Issued for Informa	tion		12.05.22
P02	Issued for Informa	tion		25.04.22
P01	Issued for Coordin	ation		01.04.22
Revision		Amendment		Date

LP	CD	MEPB
Drawn by	Reviewed by	Approved by
60715A	03/03/22	1 : 200 @ A1
MCB Number	Date Created	Scale @ A1

5th Fl, 26 Finsbury Square London EC2A 1DS +44 (0)20 7786 7900 mcbains.co.uk

HARLOW DISTRICT COUNCIL


HARPR - MCB - XX - SI - DR - A - 0110 | S4 - P09

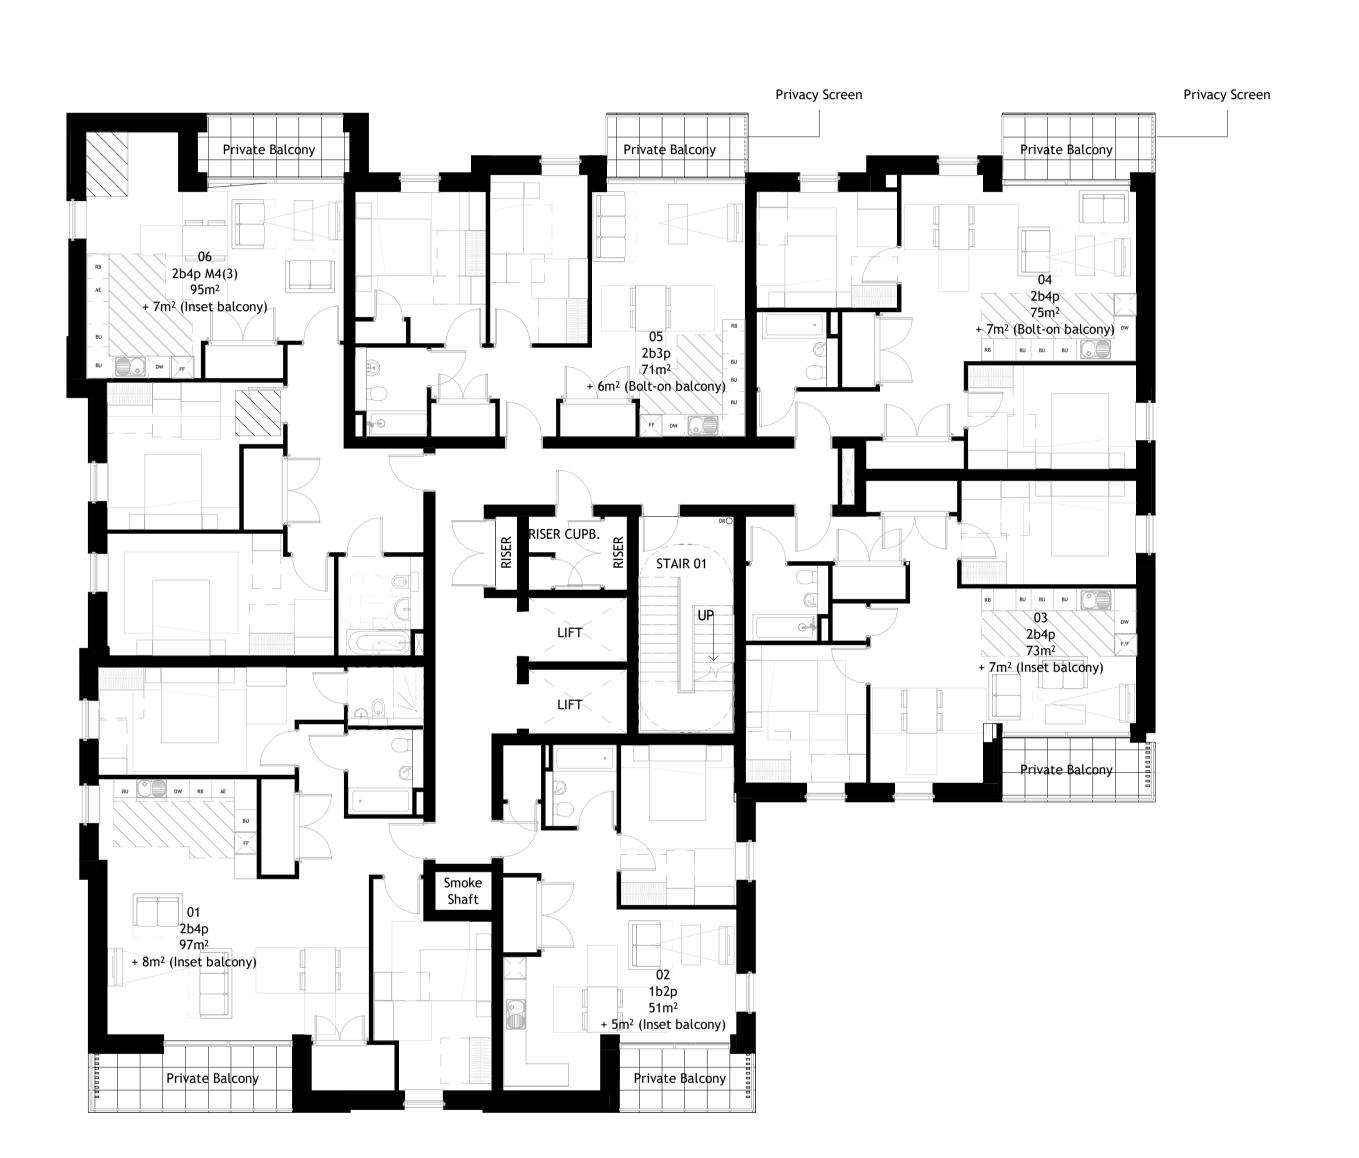

BIM Transmittal Disclaimer

McBains Ltd makes no express or implied warranties with respect to the character, function, or capabilities of the data (inclusive of 3rd party data incorporated within), or the suitability of the data for any particular purpose beyond those originally intended by McBains Ltd. please refer to our standard terms and conditions for further details.



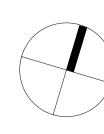

P09	Issued for Planning	21.04.23	
P08	Issued for Information	31.03.23	
C07	Stage 2 Issue	20.01.23	
P06	Issued for Information	21.12.22	
P05	Stage 3 Issue	13.06.22	
C04	Issued for Planning	25.05.22	
P03	Issued for Coordination	18.05.22	
P02	Issued for Coordination	29.04.22	
P01	Issued for Coordination	01.04.22	
Revision	Amendment	Date	

LP CD MEPB Drawn by Reviewed by Approved by			
Drawn by Reviewed by Approved by	LP	CD	MEPB
	Drawn by	Reviewed by	Approved by
60715A 03/03/22 1 : 100 @ A1	60715A	03/03/22	1 : 100 @ A1
MCB Number Date Created Scale @ A1	MCB Number	Date Created	Scale @ A1

5th Fl, 26 Finsbury Square London EC2A 1DS +44 (0)20 7786 7900 mcbains.co.uk

HARLOW DISTRICT COUNCIL

PERRY ROAD, HARLOW ESSEX, CM18 7LT

Drawing Title PROPOSED - THIRD FLOOR PLAN

HARPR - MCB - XX - 03 - DR - A - 0300 | S4 - P09