

Rev	Date	Issued	Checked	Description
		by	by	
1	28/06/22	KC	MC	Option with revised roofscape issued to client for comment
2	05/07/22	MC	MC	Pre-application issue
3	10/02/23	KC	MC	Planning Issue

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5) If in doubt ask!





2 Location Plan
1: 1250



VISUAL SCALE 1:100 @ A1



DWW DESIGN | FIELD HOUSE | STATION APPROACH | HARLOW CM20 2FB

CLIENT

Harlow Council

JOB TITLE

Pytt Field, Harlow

DRAWING TITLE

Job/ Dwg No/ Rev: HD21050 1001


 Drawn:
 Checked:
 Appr:
 Date:

 JH
 KC
 MC
 17/02/22


 Drawing status:
 PLANNING
 Scale:

Scale:
As indicated @A1


3

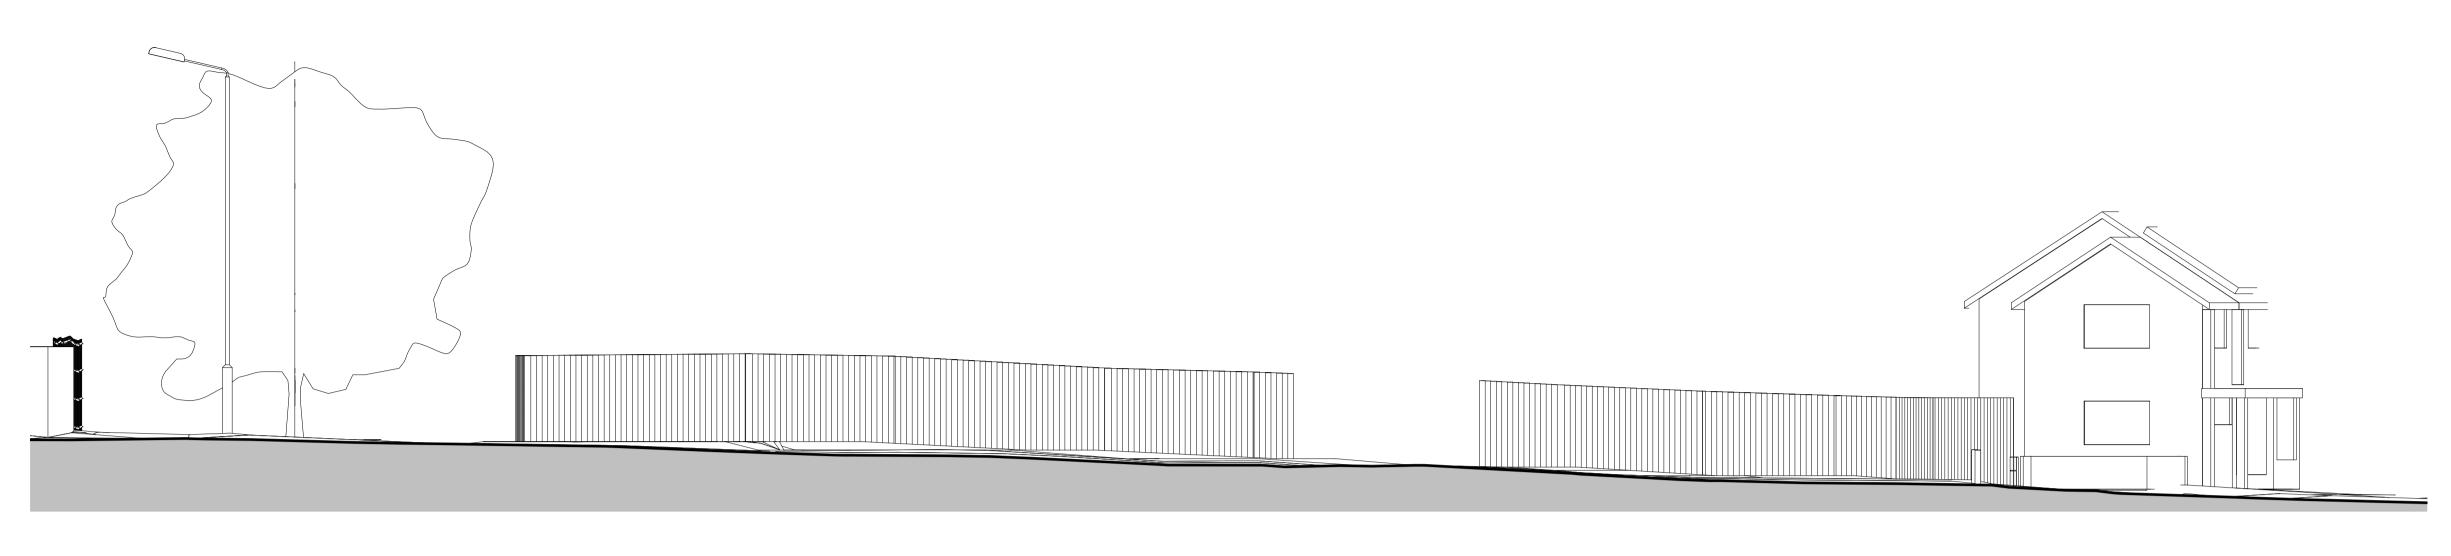

1 Existing Front (West) Elevation

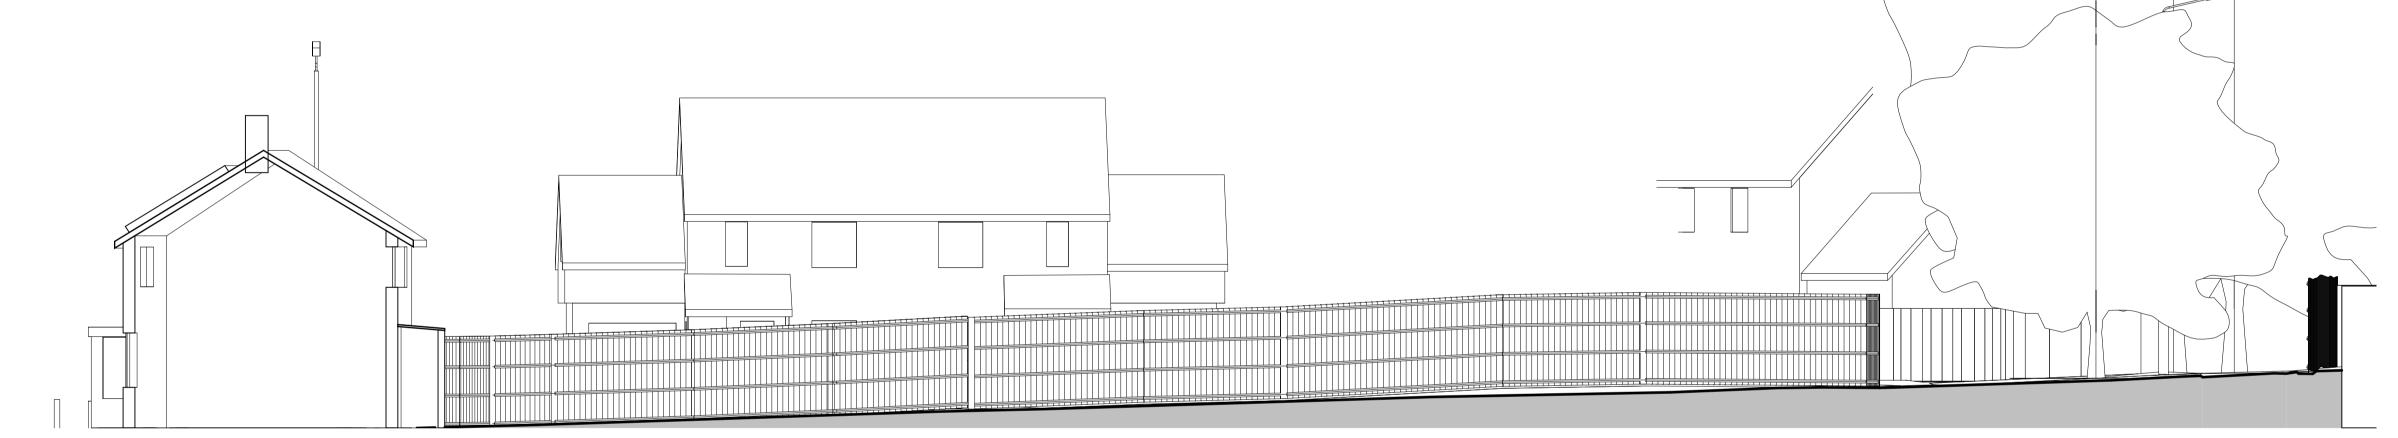

3 Existing Rear (East) Elevation
1:100

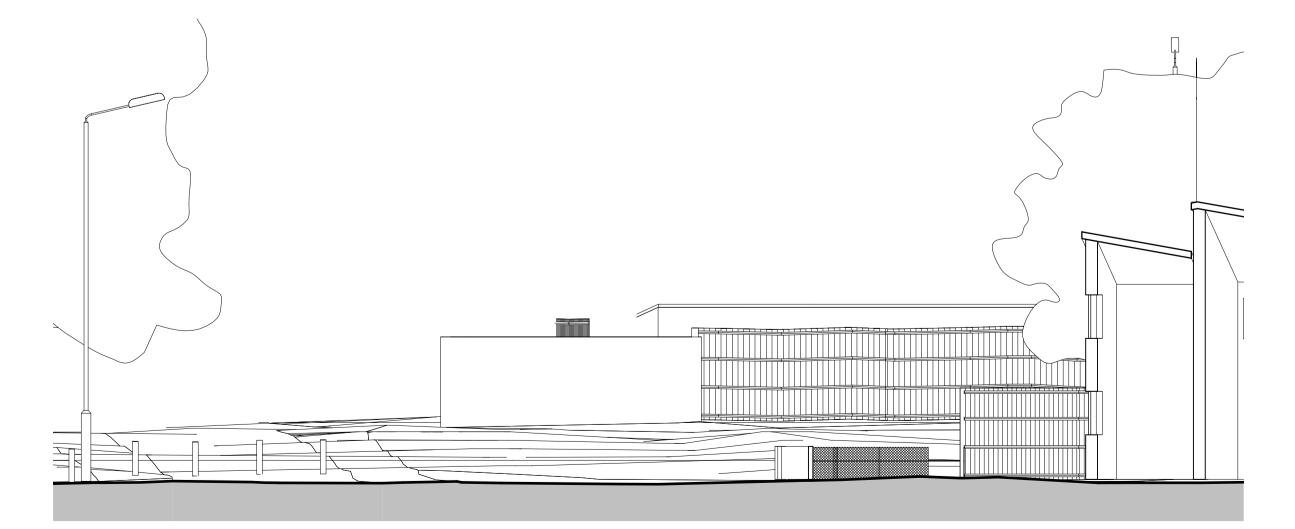

2 Existing Flank (South) Elevation
1:100



4 Existing Flank (North) Elevation
1:100

Rev	Date	Issued	Checked	Description
		by	by	
1	21/03/22	KC	MC	Preliminary issue to Client
2	05/07/22	MC	MC	Pre-application issue
3	04/04/23	KC	MC	Planning issue

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DWW DESIGN | FIELD HOUSE | STATION APPROACH | HARLOW CM20 2FB


Harlow Council

JOB TITLE

Pytt Field, Harlow DRAWING TITLE

Existing Site Elevations

Job/ Dwg No/ Rev:	HD21050	2001	3	
Drawn:	Checked:	Appr:	Date:	
JH	KC	MC	02/25/22	
Drawing status:	PLANNIN	G	Scale:	
			1 : 100	@A′

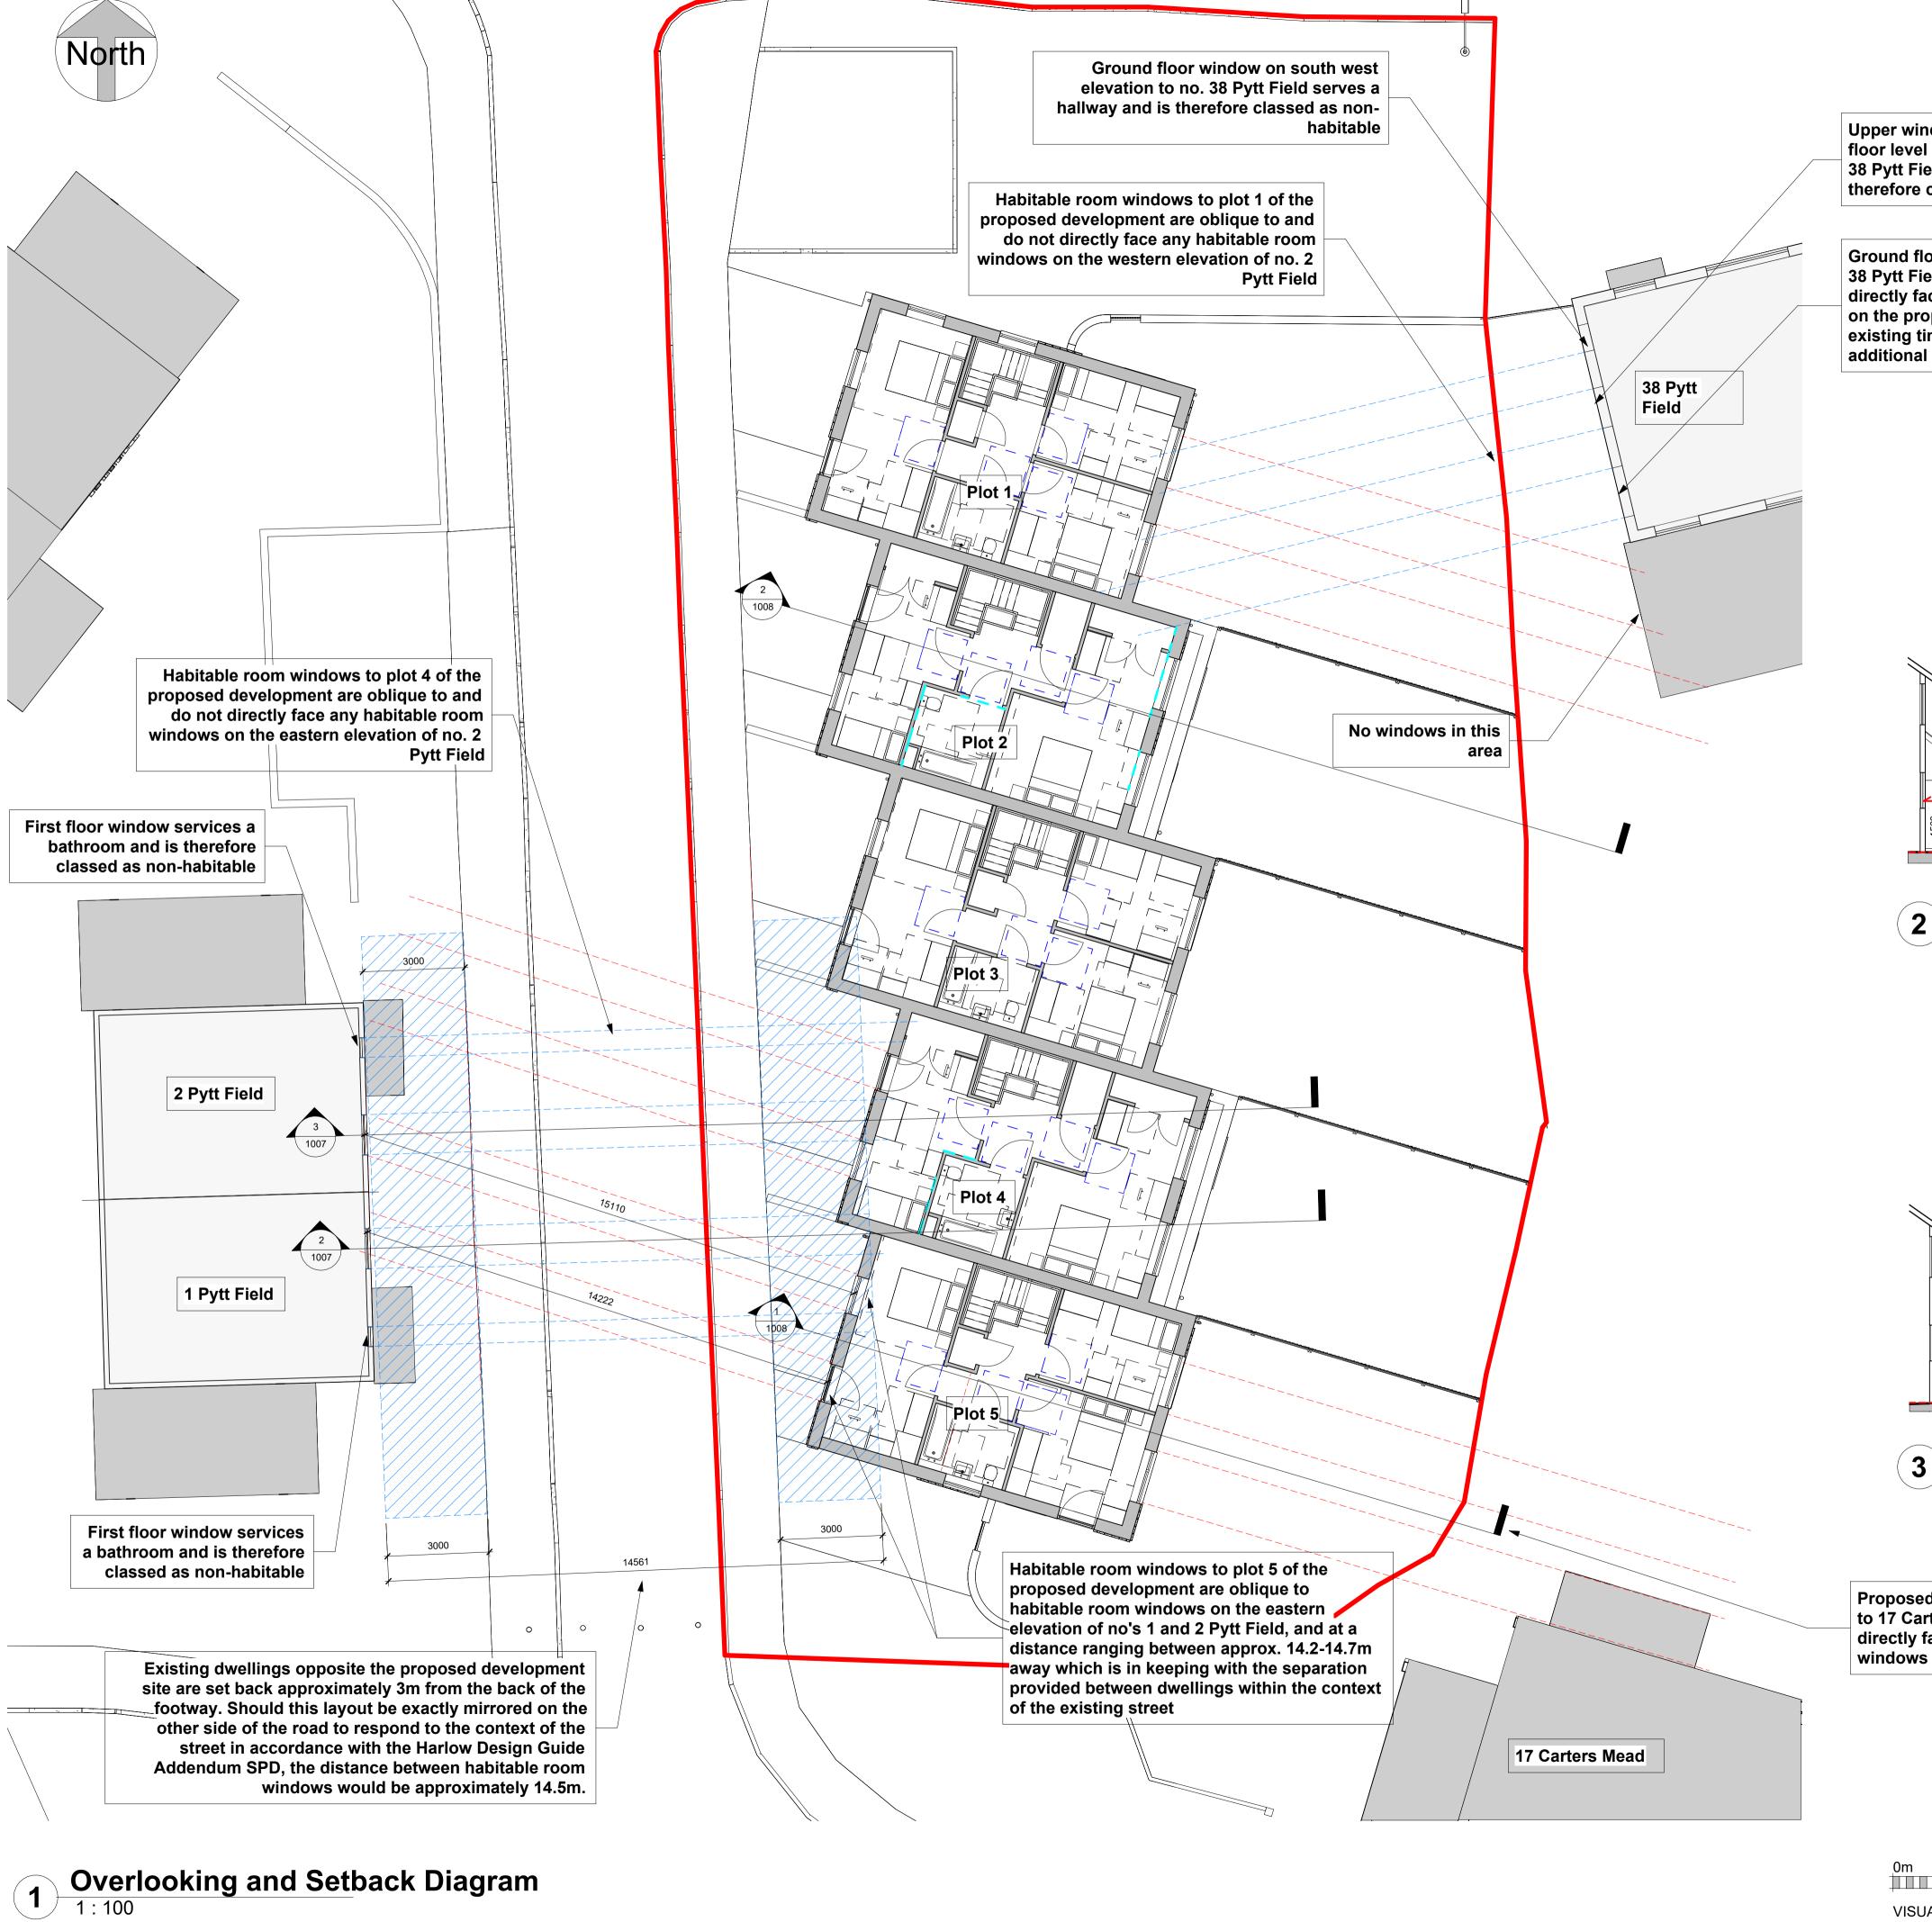

Upper window between ground and first floor level on south west elevation to no. 38 Pytt Field serves a staircase and is therefore classed as non-habitable

Ground floor habitable room window to no. 38 Pytt Field is oblique to and does not directly face any habitable room windows on the proposed development, and the existing timber boundary fence provides additional privacy

Issued Checked Description


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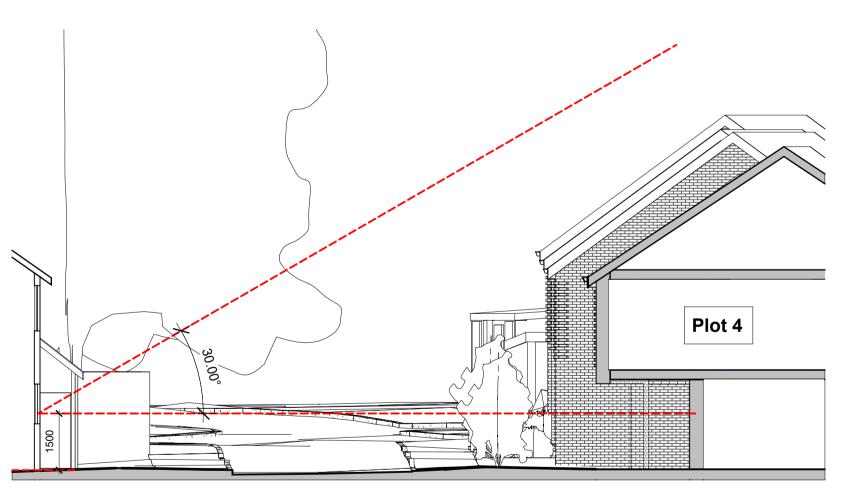
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2 1 Pytt Field Massing Impact Assessment 1:100



3 2 Pytt Field Massing Impact Assessment 1:100

Proposed development is at 90 degrees to 17 Cartersmead and does not directly face any habitable room

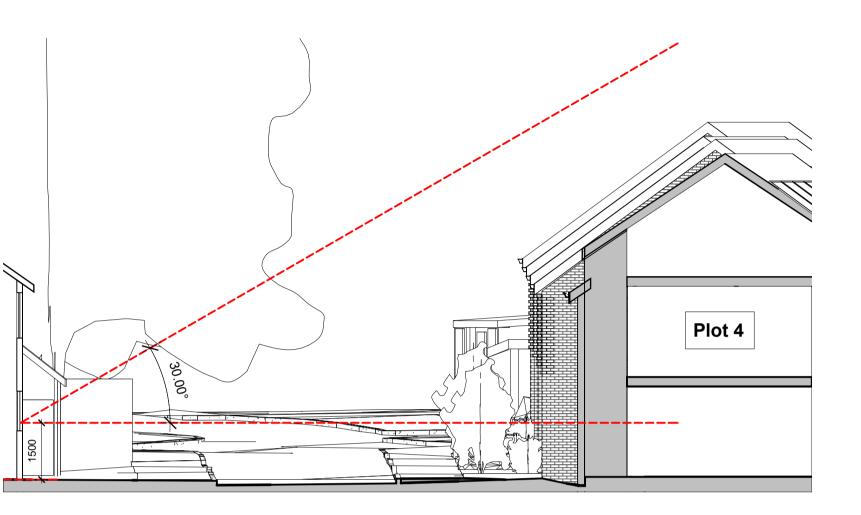

DWW DESIGN | FIELD HOUSE | STATION APPROACH | HARLOW CM20 2FB

Harlow Council

JOB TITLE

Pytt Field, Harlow


DRAWING TITLE

Overlooking and Massing Impact Assessment Shtwfloofv2 HD21050 1007


Date: MC MC 29/01/23 **PLANNING**

VISUAL SCALE 1:100 @ A1

1:100

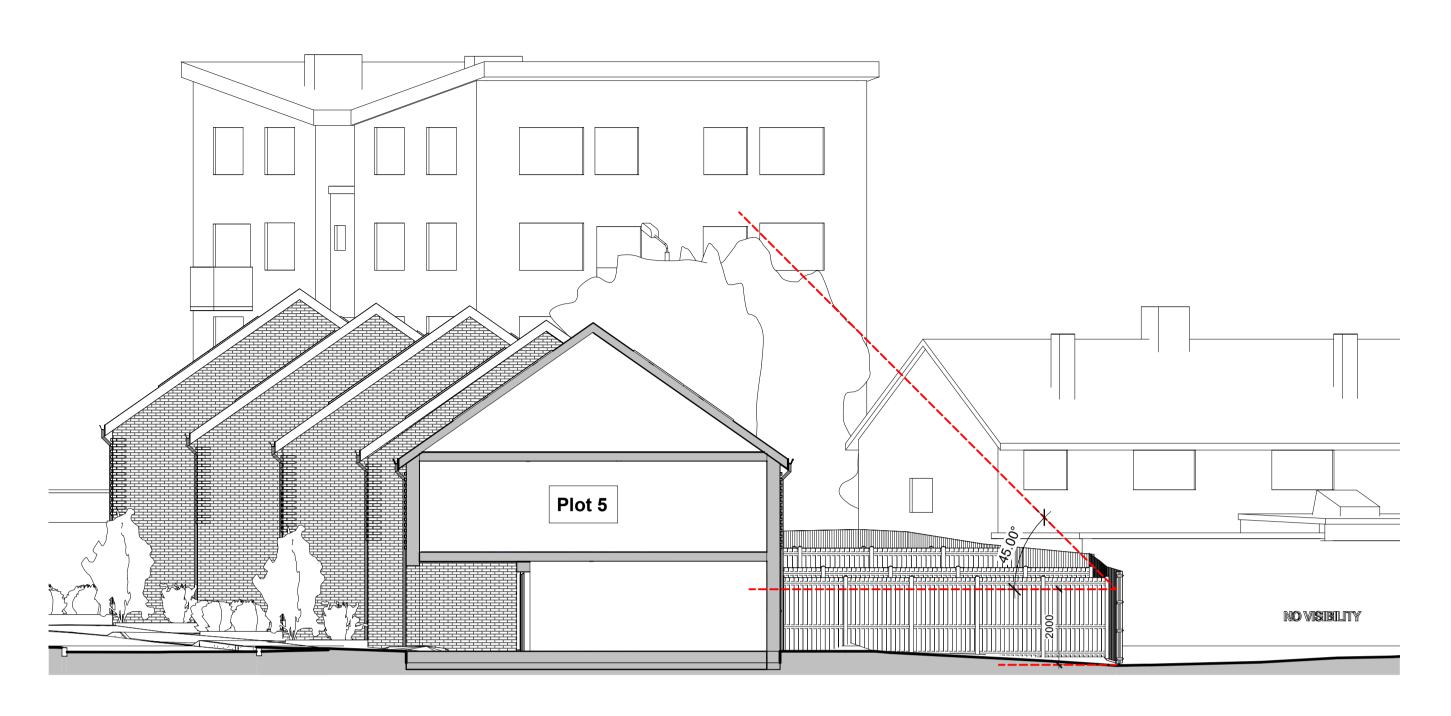

1 Amenity Space Impact Assessment 17 Carters Mead

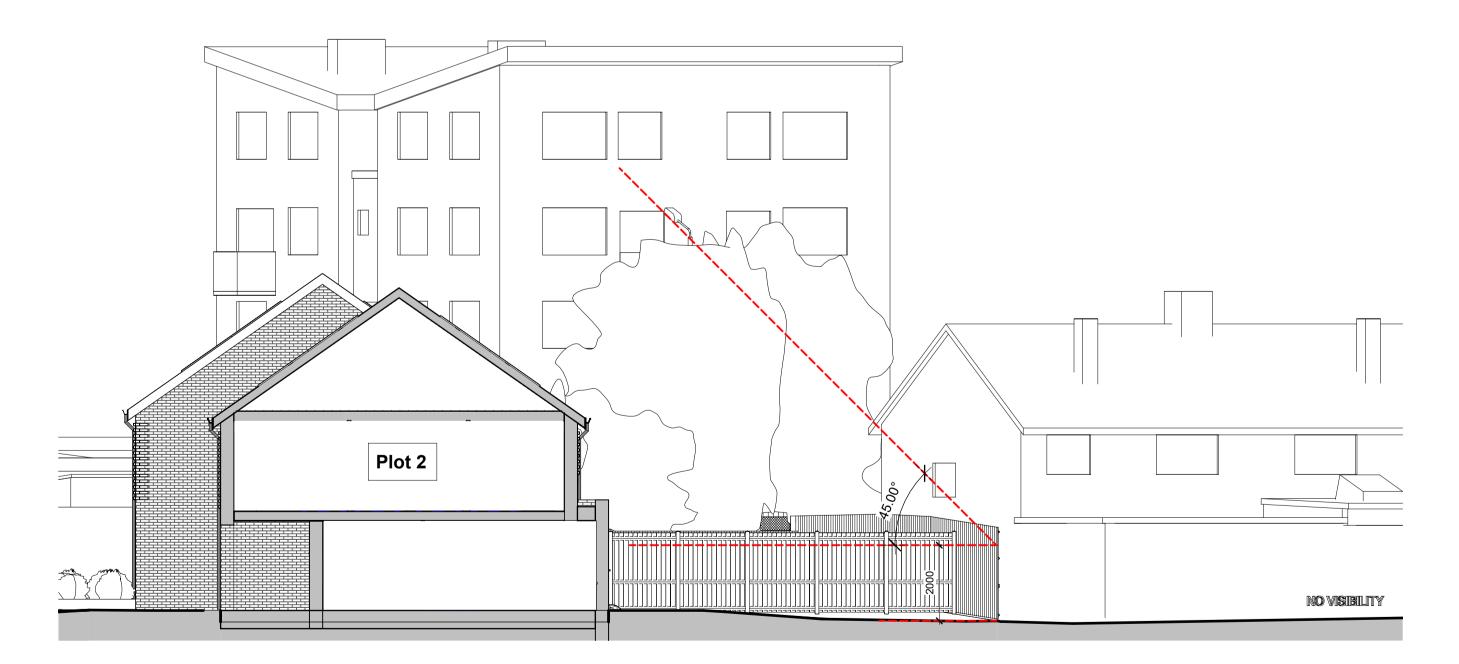

Amenity Space Impact Assessment 38 Pytt Field

1: 100

Privacy and Overlooking Notes

The proposed development has been designed to ensure a good level of privacy inside the proposed and surrounding, existing, buildings and within private outdoor space and care has been taken to balance privacy with the desire for an active frontage and the overlooking of public spaces.

Directly facing habitable room windows have been avoided.

A distance of 9 metres has been maintained between gardens and habitable rooms.

The frontages of the proposed dwellings are angled to maximise the distance between the proposed development and existing dwellings in the context of the development site and to avoid direct facing windows. Separation distances are informed by the prevailing urban grain.

Windows to side elevations have been designed to direct views towards public realm, improving passive surveillance whilst avoiding overlooking.

The proposed development is set below a line of 30 -degrees from the nearest habitable room window of adjoining existing properties

Where the proposed development adjoins private amenity/garden areas, the height of the development is set below a line of 45 -degrees at the garden edge, measured from a height of 2 metres above the ground.

Rev	Date	Issued by	Checked by	Description
1	10/02/23	KC	MC	Planning Issue

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VISUAL SCALE 1:100 @ A1



DWW DESIGN | FIELD HOUSE | STATION APPROACH | HARLOW CM20 2FB

Harlow Council

JOB TITLE

Pytt Field, Harlow

DRAWING TITLE

Overlooking and Massing Impact Assessment Shtv2100fv2 HD21050 1008

27/01/23 MC **PLANNING**

1:100 @A1



1 North 3D view



2 South 3D view

Rev	Date	Issued	Checked	Description
		by	by	
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3	22/12/22	KC	MC	Post pre-application design update
4	10/02/23	KC	MC	Planning Issue

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DWW DESIGN | FIELD HOUSE | STATION APPROACH | HARLOW CM20 2FB

CLIENT


Harlow Council

JOB TITLE

Pytt Field, Harlow DRAWING TITLE


Proposed 3D Views

Drawing status:	PLANNIN	G	Scale:
Author	Checker	Approver	02/25/22
Drawn:	Checked:	Appr:	Date:
Job/ Dwg No/ Rev:	-HD21050	3001	4

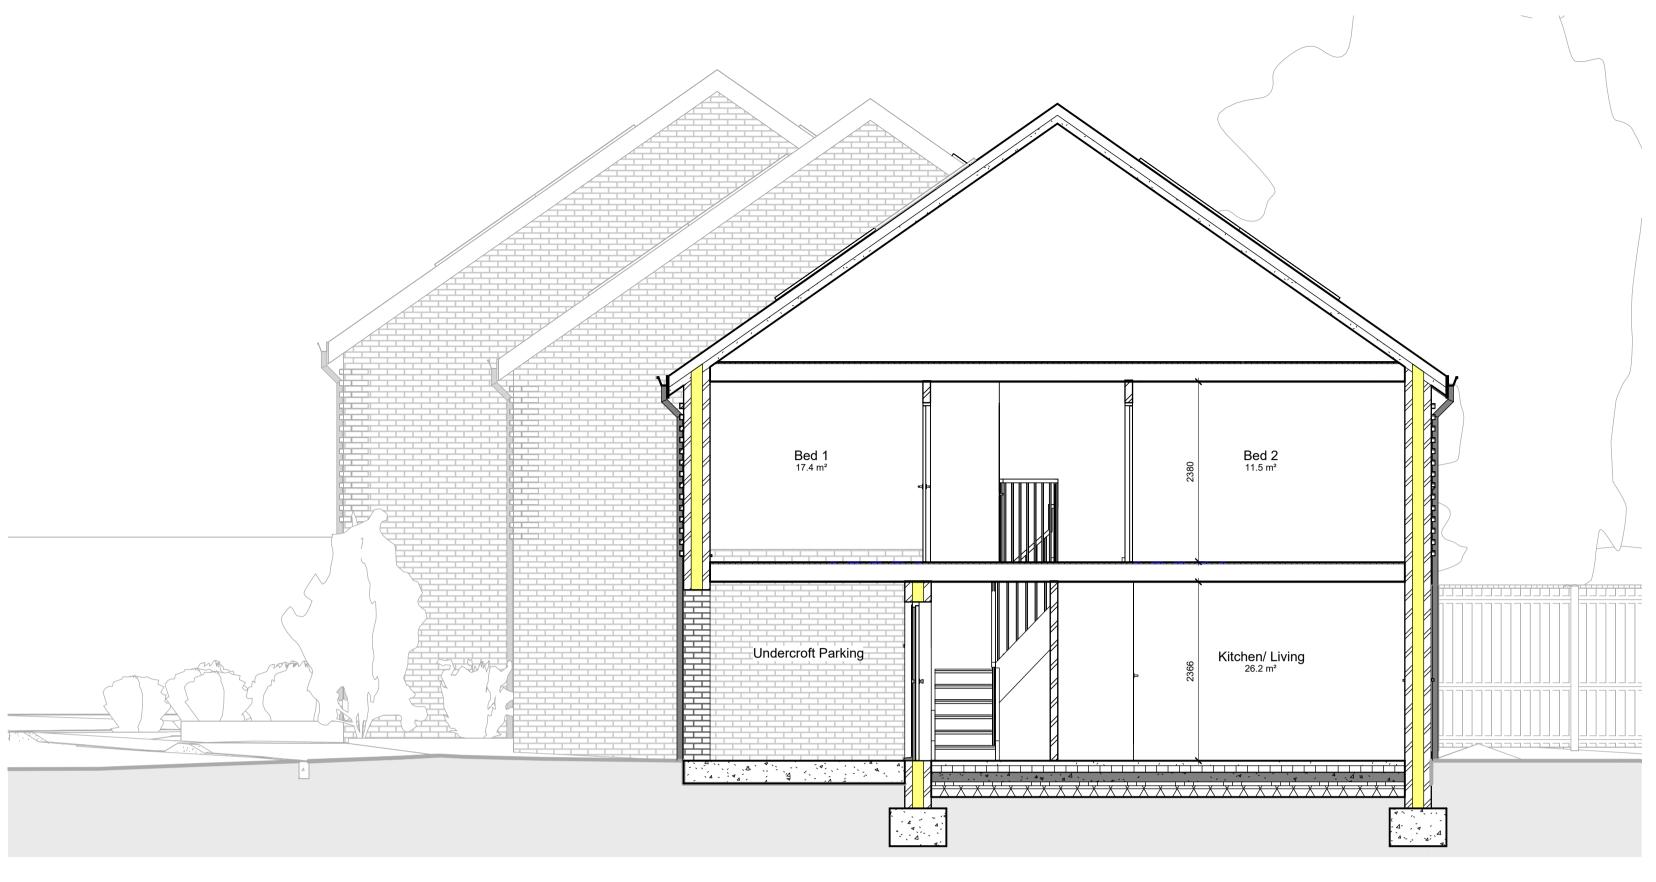

Section B-B through Plot 3

1:50

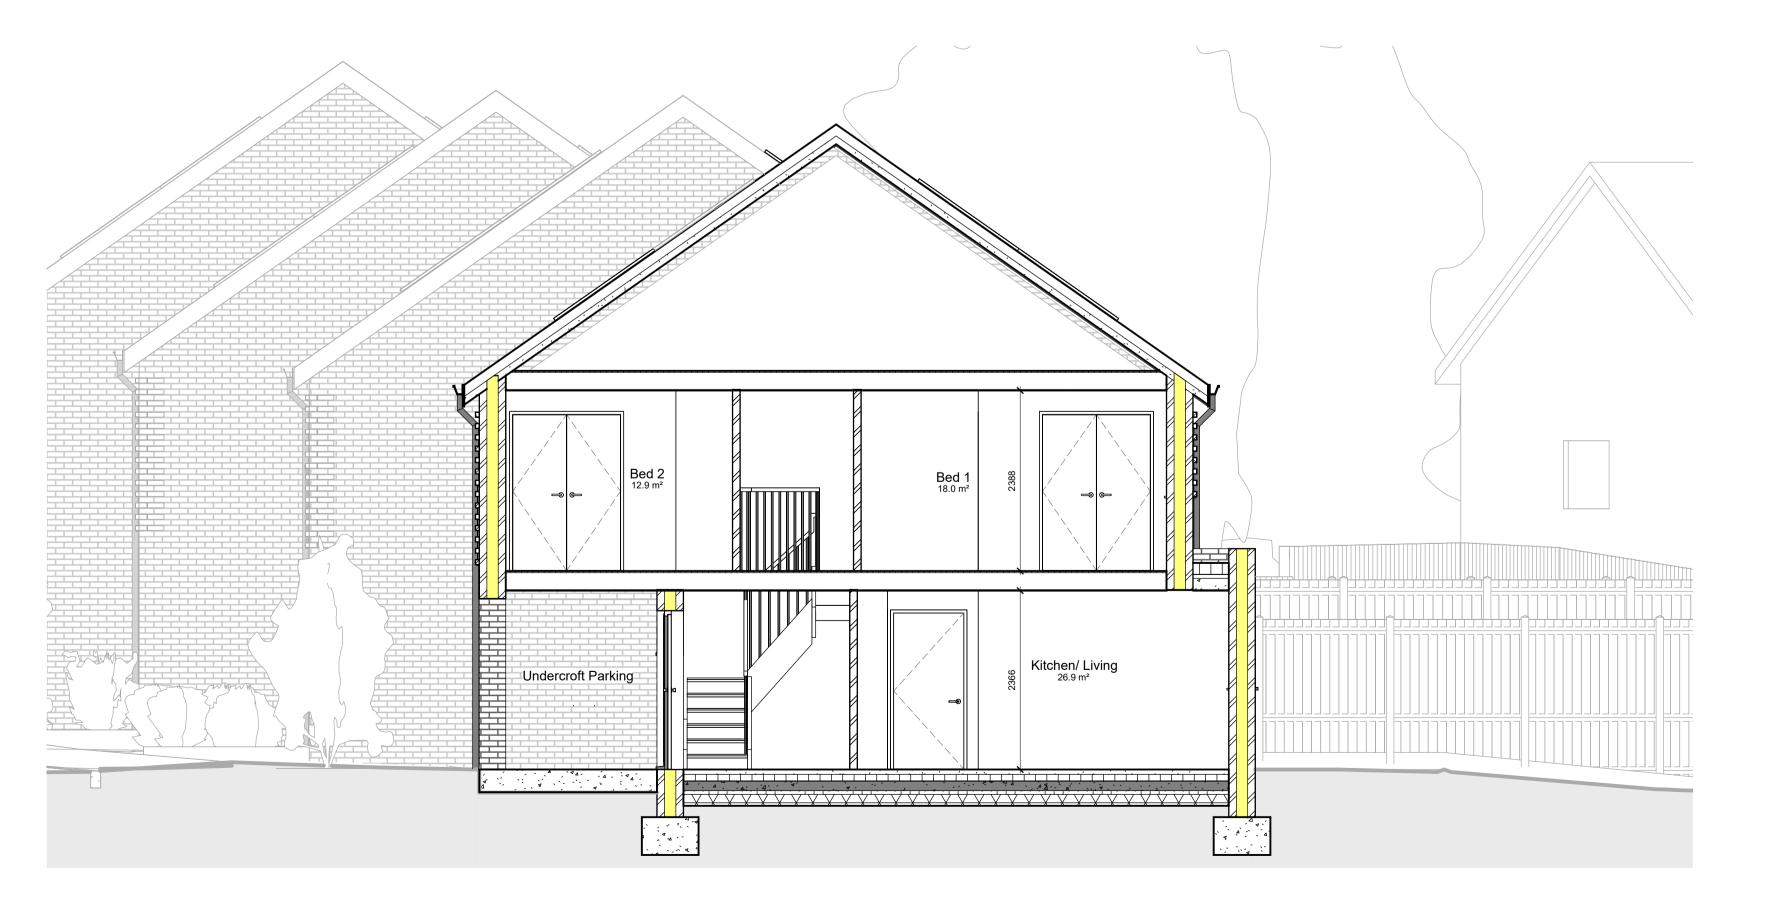

2 Section C-C through Plot 4

Rev	Date	Issued by	Checked by	Description
1	10/02/23	KC	MC	Planning Issue

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DWW DESIGN | FIELD HOUSE | STATION APPROACH | HARLOW CM20 2FB

CLIENT

Harlow Council

JOB TITLE

Pytt Field, Harlow

DRAWING TITLE

Proposed Cross Sections

•				
Job/ Dwg No/ Rev:	HD21050	2102	1	
Drawn:	Checked:	Appr:	Date:	
KC	MC	MC	23/01/23	
Drawing status:	PLANNIN	G	Scale:	
			1 : 50	@A1



Landscaping and Biodiversity Key



Permeable block paving



Smooth paving slabs



Wildflower meadow



Lawn



Hedge - beech "Daywick Purple" (Fagus sylvatica "Dawyck P"urple planted in 3l pots at max. 500mm centres



Daffodil "Niveth" (Narcissus "niveth") planted at 300mm centres in clumps of 4 bulbs in within grass in areas indicated



Integral enclosed bat boxes by Ibstock placed near to eaves or ridge in locations shown on south east and south west elevations



3 no. "Bee Bricks" to be placed randomly within the south western face of the wall only, a minimum of 1m above the ground

Free movement of hedgehogs is to be



encouraged by providing holes 13cm x 13cm in size at the bottom of fences in the locations shown, and leaving a 13cm gap at the bottom of garden gates



Standard brick bird house placed 5m above ground on north eastern facing gable of terrace


Proposed Trees

- T1 Apple "Cox Self Fertile" half standard max. spread 4m
- T2 Betula utilis var. jacquemontii "Trinity College" max spread. 4m
- T3 Plum "Victoria" (prunus domestica) max spread.

Proposed Planting

- s Glaucous sedge (Carex Flacca) planted in 2l pots at max 500mm centres as indicated
- lv English lavender 'Loddon Blue' (Lavandula angustifolia) planted at 2l pots at max 300mm centres as indicated
- sa Sage "Purple Queen" (Salvia) planted in 2l pots at max 400mm centres as indicated
- pc Purple cranesbill "Rosemoor" (Geranium x magnificum) planted in 3l pots at max 500mm centres as indicated
- gp Variegated greater periwinkle (Vinca Major "Variegata") planted in 2l pots at max 300mm centres as indicated
- hb Hebe "Garden Beauty Blue" planted in 2l pots at max 400mm centres as indicated
- hm Hebe "Margaret" planted in 2l pots at max 400mm cenres as indicated
- Japanese quince "Jet Trail" (Chaenomeles japonica "Jet Trail") planted in 3l pots at max 500mm centres as indicated
- hs Honeysuckle "Serotina" (Lonicera periclymenum) planted in 3l pots at max 1000mm centres as indicated adjacent to trelis
- hh English Ivy (Hedra Helix) at 5000mm centres as indicated adjacent to trelis

Note: Planting beds to front of dwellings to be treated with bark mulch between all plants

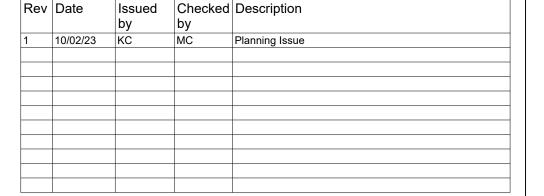

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VISUAL SCALE 1:100 @ A1



DWW DESIGN | FIELD HOUSE | STATION APPROACH | HARLOW CM20 2FB

CLIENT **Harlow Council**

JOB TITLE


KC

Pytt Field, Harlow


DRAWING TITLE Proposed Parking, Landscaping and

Biodiversity Plan HD21050 1006 Date: MC MC 06/01/23 **PLANNING** Drawing status:


1:100

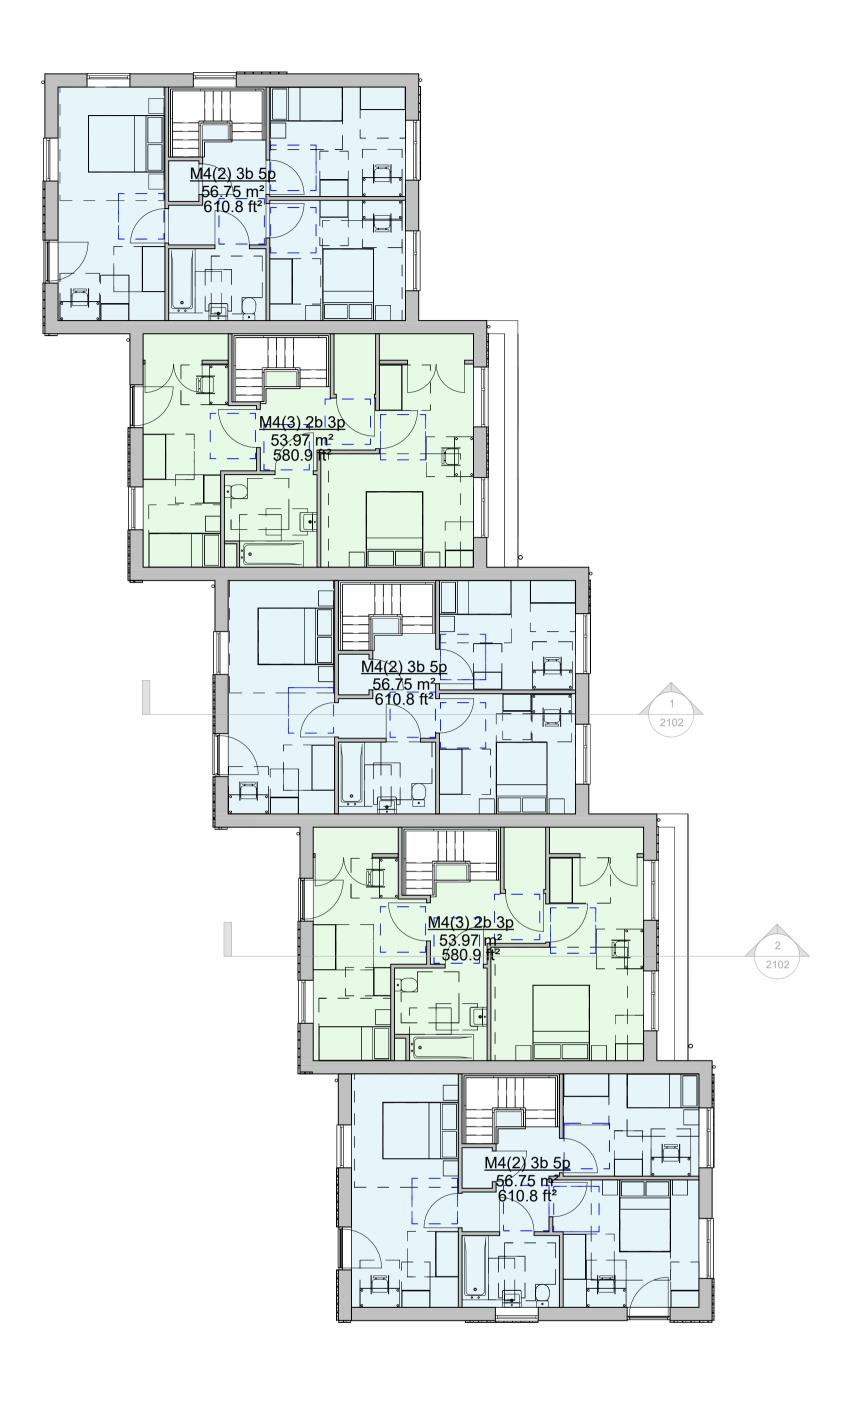


1 01 First Floor Occupancy Plan 1:100

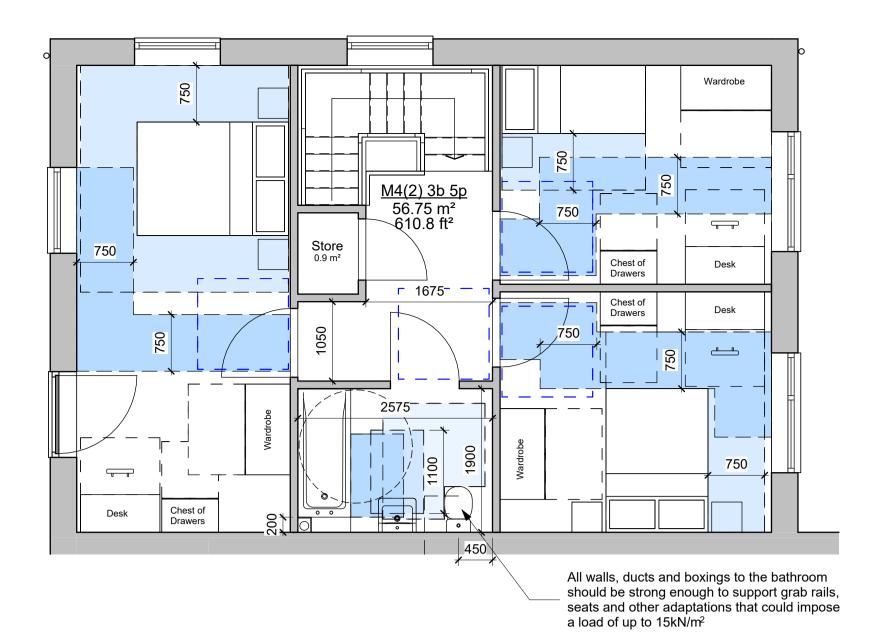

2 01 M4(2) 3 Bed 5 Person Unit (Plots 1 and 3)

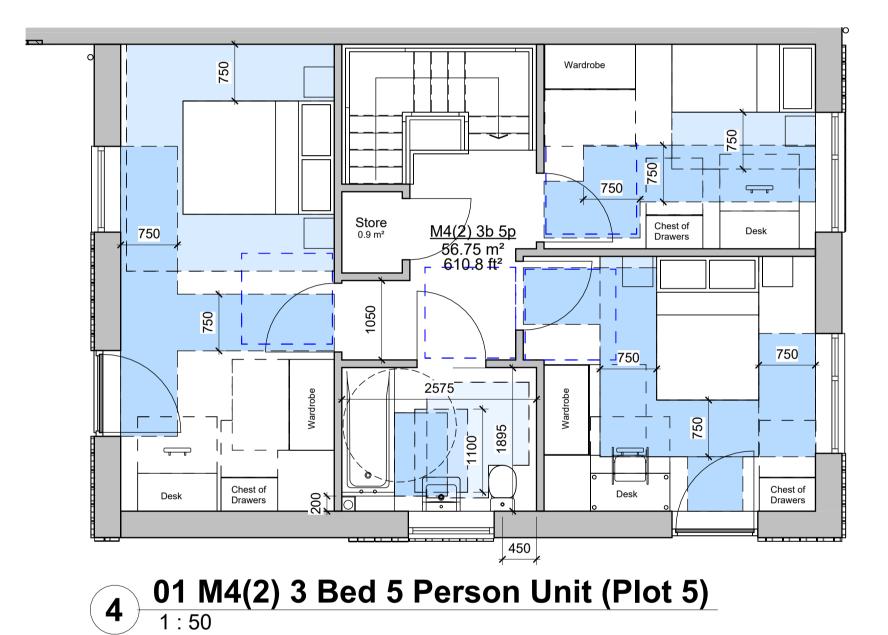


The ceiling structure of every bedroom is to be strong enough to allow for the fitting of an overhead hoist capable of carrying a load of 200kg Store 1.6 m²

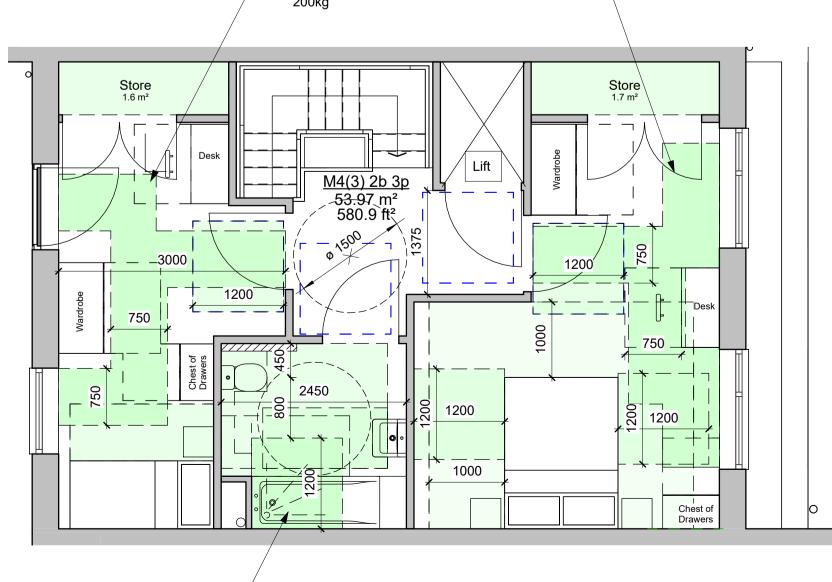

a load of up to 15kN/m² 3 01 M4(3) 2 Bed 3 Person Unit 1:50

All walls, ducts and boxings to the bathroom

should be strong enough to support grab rails, seats and other adaptations that could impose

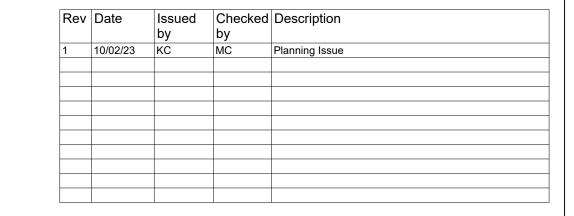

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Services and Controls in M4(2) Units

- Consumer units are mounted so that the switches are between 1350mm and 1450mm above floor level.
- Switches, sockets, stopcocks and controls have their centre line between 450mm and 1200mm above floor level and a minimum of 300mm (measured horizontally from an
- The handle to at least one window in the principal living area is located between 450mm and 1200mm above floor level, unless the window is fitted with a remote opening device that is within this height range.
- Handles to all other windows are located between 450mm and 1400mm above floor level, unless fitted with a remote opening device that is within this height range.

• boiler timer controls and thermostats are mounted between 900mm and 1200mm above finished floor level on the boiler, or • separate controllers (wired or wireless) are mounted elsewhere in an accessible location

within the same height range.

Services and Controls M4(3) Units

Consumer units should be mounted so that the switches are between 1350mm and 1450mm above floor level.

(Note: Controls that are part of a radiator or cooker hood are exemot from these provisions.)

- Switches, sockets, stopcocks and controls, except controls to radiators, are located with their centre line 700-1000mm above floor level and a minimum of 700mm (measured horizontally) from an inside corner, and are not positioned behind appliances.
- Kitchen appliances in wheelchair accessible dwellings have isolators located within the same height range.
- The handle to at least one window in the principal living area is 700-1000mm above floor level, unless fitted with a remote opening device that is within this height range
- Handles to all other windows are 450-1200mm above floor level, unless the window is fitted with a remote opening device that is within this height range. Door handles, locks, latches and catches are both:

easy to grip and use, and

- Light switches are on individual plates unless wide rocker or full plate fittings are provided.
- Switches to double socket outlets are located at the outer ends of the plate (rather than in
- A door entry phone with remote door release facility is provided in the main living space and the principal bedroom.
- Suitable provision is made in the principal bedroom to install bedhead controls in the future (comprising a 2-way light switch, telephone and broadband socket, TV aerial and power socket outlets, and the door entry phone provision described above, grouped adjacent to the head of the bed), for example, by providing blank sockets, conduit and
- A main electrical power socket and a telephone point are provided together in the main
- Taps and bathroom controls are suitable for a person with limited grip to operate and for single handed operation.
- Boiler timer controls and thermostats are either mounted 900-1200mm above finished floor level on the boiler, or separate controllers (wired or wireless) are mounted elsewhere in an accessible location within the same height range.
- In wheelchair accessible dwellings, radiator controls are mounted 450-1000mm above floor level.



DWW DESIGN | FIELD HOUSE | STATION APPROACH | HARLOW CM20 2FB

Harlow Council

JOB TITLE

VISUAL SCALE 1:50 @ A1


VISUAL SCALE 1:100 @ A1

Pytt Field, Harlow


DRAWING TITLE **Proposed Part M Compliance First Floor**


HD21050 1012 KC MC 04/01/23 MC Drawing status: **PLANNING**

As indicated @A1

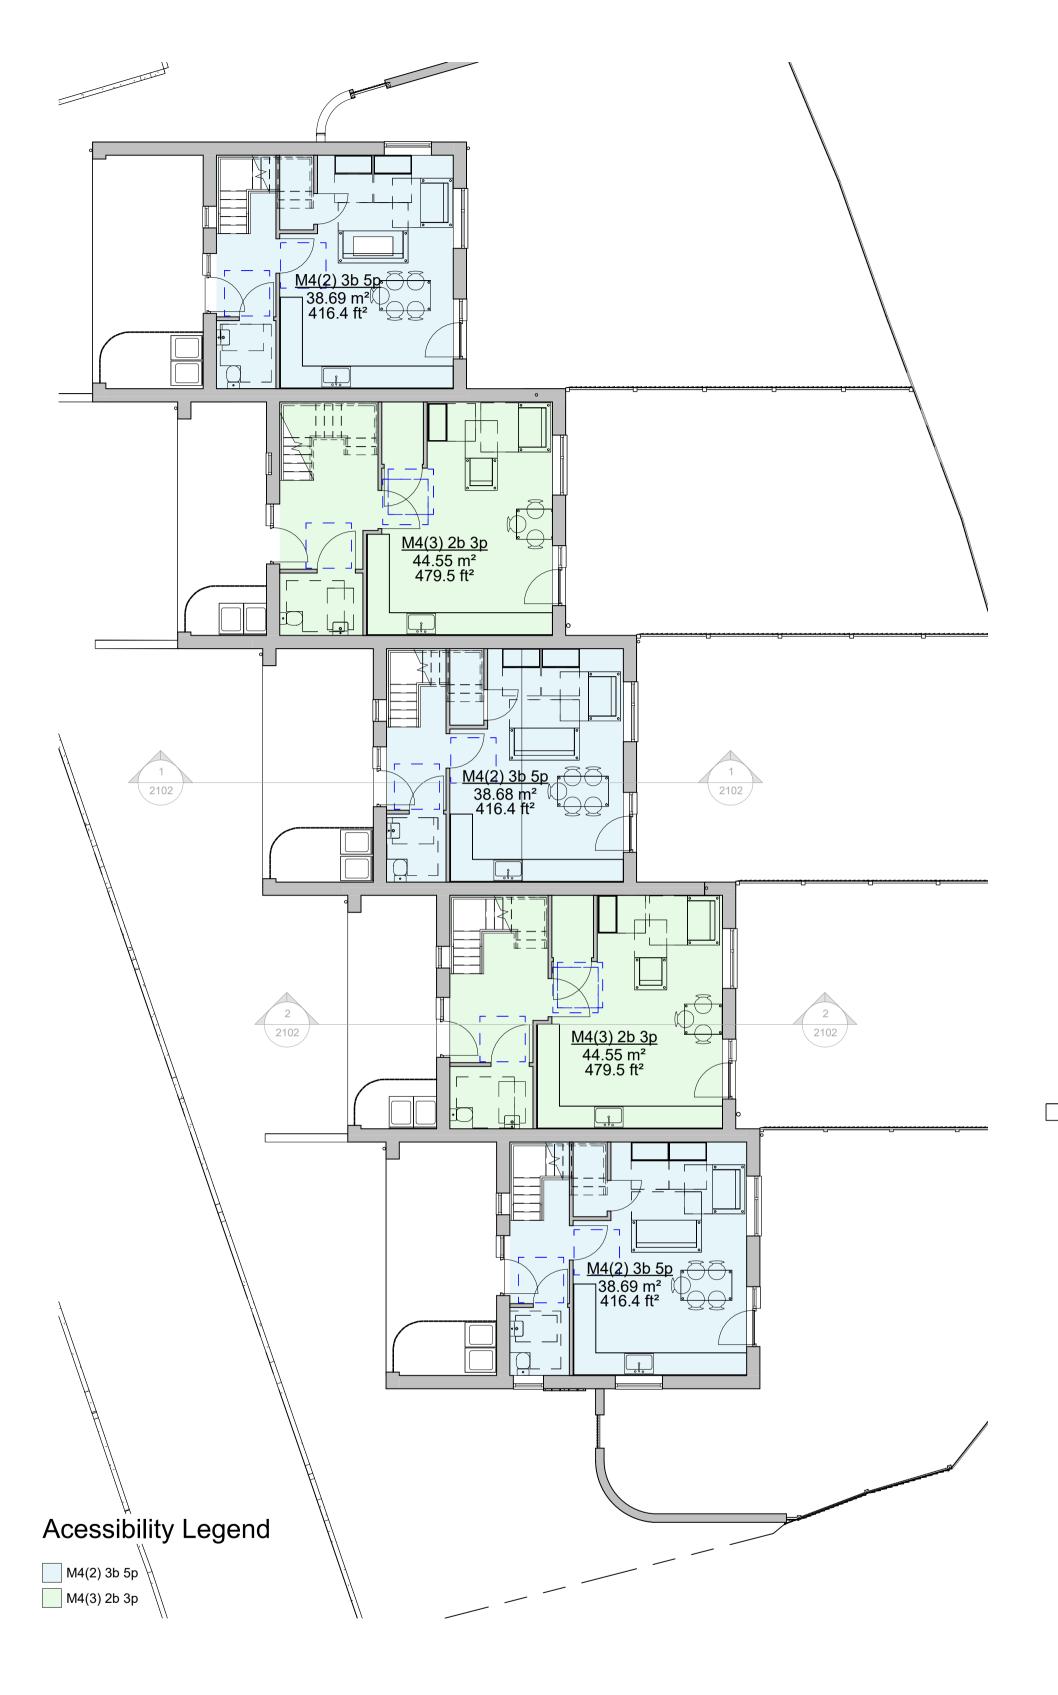



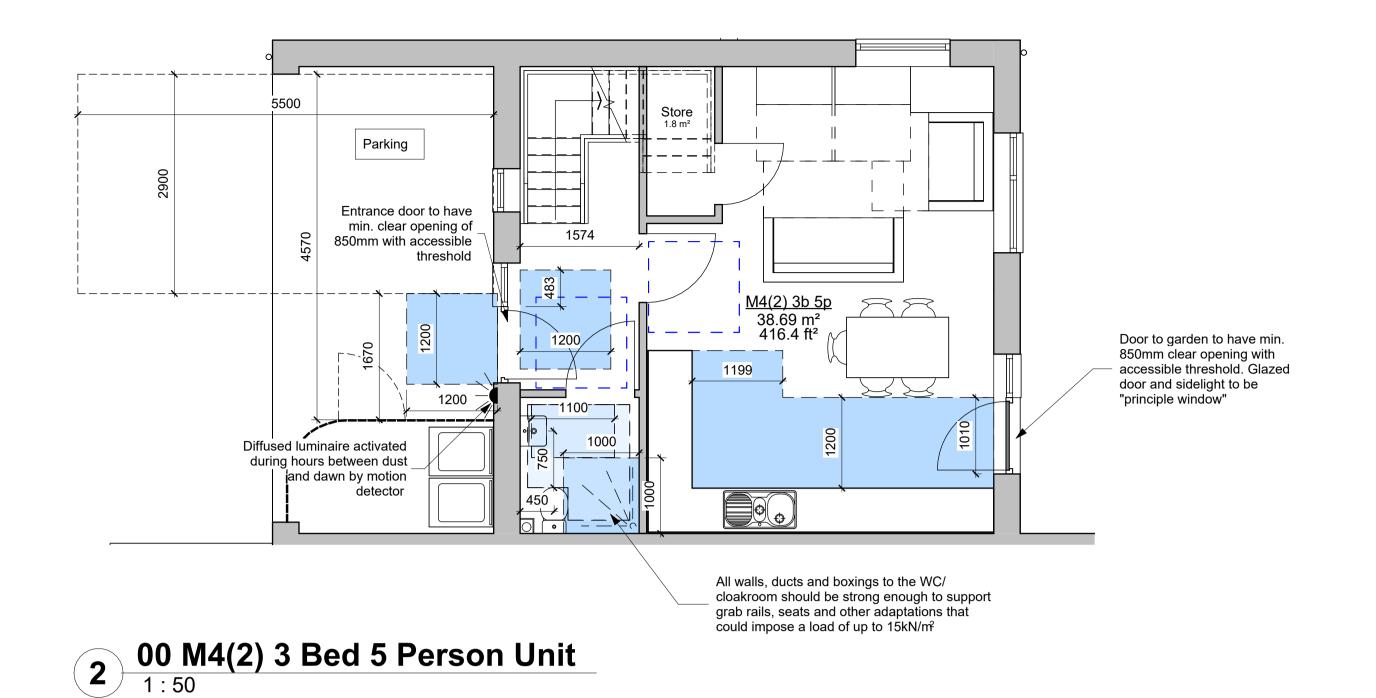

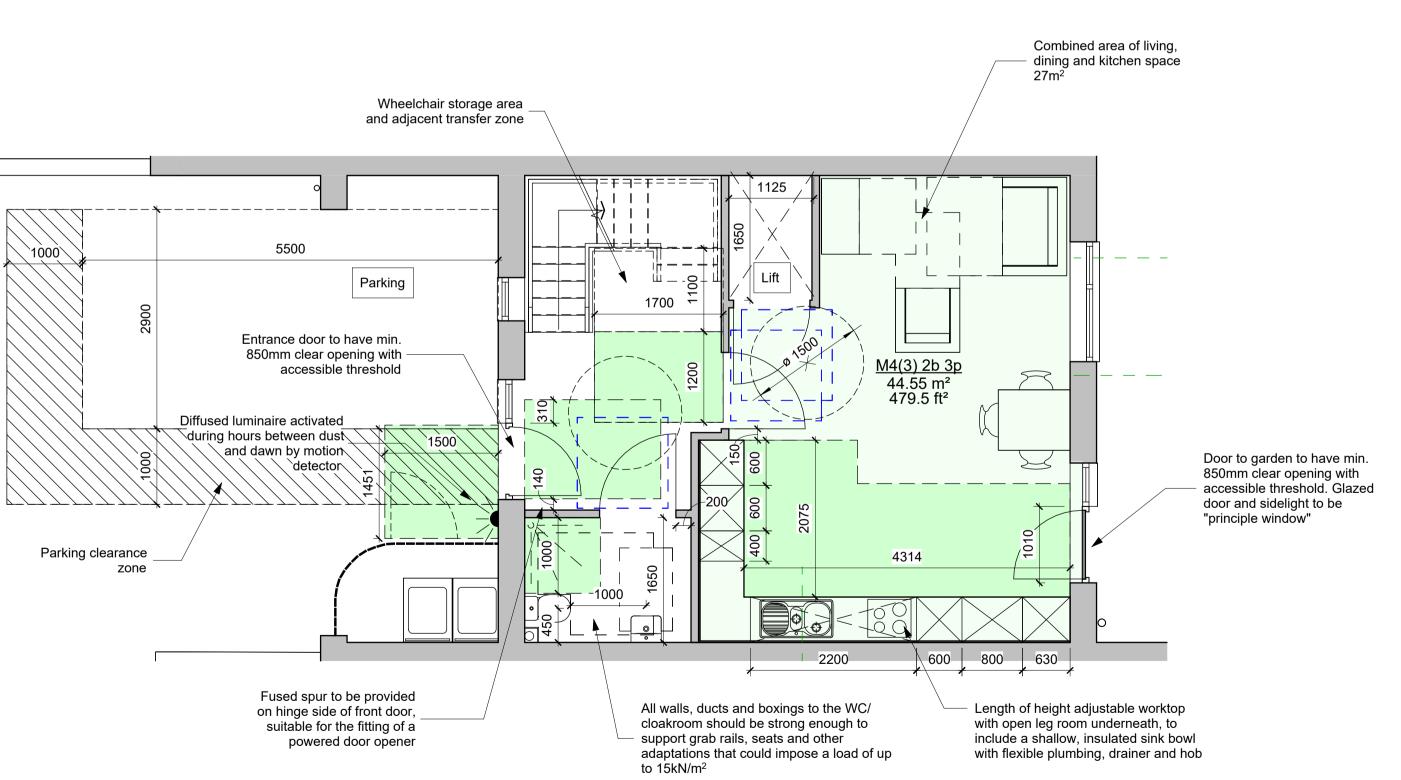

3 00 M4(3) 2 Bed 3 Person Unit

VISUAL SCALE 1:50 @ A1 2m

VISUAL SCALE 1:100 @ A1

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		by	by	
1	10/02/23	KC	MC	Planning Issue

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DWW DESIGN | FIELD HOUSE | STATION APPROACH | HARLOW CM20 2FB

CLIENT

Harlow Council

JOB TITLE

Pytt Field, Harlow DRAWING TITLE

Proposed Part M Compliance Ground Floor

Job/ Dwg No/ Rev:	HD21050	1011	1	
Drawn:	Checked:	Appr:	Date:	
KC	MC	MC	04/01/23	
Drawing status:	PLANNIN	G	Scale:	

As indicated @A1



1 Proposed Front (West) Elevation



Proposed Rear (East) Elevation (fences hidden)

1: 100



3 Proposed Flank (South) Elevation 1:100



Proposed Flank (North) Elevation
1:100

Rev	Date	Issued	Checked	Description
		by	by	
1	28/06/22	KC	MC	Option with revised roofscape issued to client for commen
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3	22/12/22	KC	MC	Post pre-application design update
4	10/02/23	KC	MC	Planning Issue

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10m	

VISUAL SCALE 1:100 @ A1



DWW DESIGN | FIELD HOUSE | STATION APPROACH | HARLOW CM20 2FB

Harlow Council

JOB TITLE Pytt Field, Harlow

DRAWING TITLE

Proposed Site Elevations							
Job/ Dwg No/ Rev:	HD21050	2002	4				
Drawn:	Checked:	Appr:	Date:				
JH	KC	MC	17/02/22				
Drawing status:	PLANNIN	Scale:					

1:100



Rev	Date	Issued	Checked	Description
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1	28/06/22	KC	MC	Option with revised roofscape issued to client for commen
2	05/07/22	MC	MC	Pre-application issue
3	22/12/22	KC	MC	Post pre-application design update
4	20/01/23	KC	MC	Interim issue for consultant reports
5	10/02/23	KC	MC	Planning Issue
6	04/04/23	KC	MC	Update to tree planting and biodiversity features

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Plot Schedule									
Plot No.	GIA	Occupancy	Accessibility	In-Built Storage	External Amenity Area				
Plot 1	95 m2	3b 5p	M4(2)	2.7 m2	102.5 m2				
Plot 2	99 m2	2b 3p	M4(3)	3.3 m2	68m2				
Plot 3	95 m2	3b 5p	M4(2)	2.7 m2	70m2				
Plot 4	99 m2	2b 3p	M4(3)	3.3 m2	60 m2				
Plot 5	95 m2	3b 5p	M4(2)	2.7 m2	88 m2				

Note: For full details of parking, refuse and cycle storage arrangements, landscaping and biodiversity enahancements please refer to drawing HD21050-1006



VISUAL SCALE 1:100 @ A1



DWW DESIGN | FIELD HOUSE | STATION APPROACH | HARLOW CM20 2FB

CLIENT

Harlow Council

JOB TITLE

Pytt Field, Harlow

DRAWING TITLE **Proposed Site Plan**

> HD21050 1005 Date:


MC 17/02/22 KC PLANNING

1:100 @A1

6





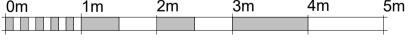

VISUAL SCALE 1:50 @ A1

Rev Date

28/06/22 KC 10/02/23 KC

Issued Checked Description

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4) The contractor is to check the drawing against all other relevant drawings, specifications and bills of quantities as issued and appropriate. Derrick Wade

Waters are to be informed of any contradictions and discrepancies.

Option with revised roofscape issued to client for comment



DWW DESIGN | FIELD HOUSE | STATION APPROACH | HARLOW CM20 2FB

CLIENT

Harlow Council

JOB TITLE

Pytt Field, Harlow

DRAWING TITLE

Proposed Site Section

Job/ Dwg No/ Rev: 11D 04 05 0

Drawing status:	PLANNIN	Scale:	
KC	MC	MC	17/03/22
Drawn:	Checked:	Appr:	Date:
OOS, DWG NO, NOV.	HD21050	2101	2

1 : 50 @A1



0m 2m 4m 6m 8m 10m VISUAL SCALE 1:100 @ A1

Rev	Date	Issued	Checked	Description
		by	by	,
1	28/06/22	KC	MC	Option with revised roofscape issued to client for commen
2	05/07/22	MC	MC	Pre-application issue
3	22/12/22	KC	MC	Post pre-application design update
4	20/01/23	KC	MC	Interim issue for consultant reports
5	02/02/23	KC	MC	Update to fenestration on south elevation
6	10/02/23	KC	MC	Planning Issue

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5) If in doubt ask!

DI-1		Schedule	Λ
Plot	Level	Name	Area
Plot 1	00 FFL	Kitchen/ Living	26.3 m ²
Plot 1	01 FFL	Bed 1	17.4 m²
Plot 1	01 FFL	Bed 2	11.4 m ²
Plot 1	01 FFL	Bed 3	10.4 m ²
Plot 1	01 FFL	Bath	4.9 m ²
Plot 1	01 FFL	Store	0.9 m ²
Plot 1	00 FFL	Store	1.8 m²
Plot 1	00 FFL	WC	2.8 m ²
Plot 2	00 FFL	Kitchen/ Living	26.8 m²
Plot 2	00 FFL	WC	3.6 m ²
Plot 2	00 FFL	Lift	1.8 m²
Plot 2	01 FFL	Bed 2	12.9 m²
Plot 2	01 FFL	Bath	5.7 m ²
Plot 2	01 FFL	Store	1.6 m ²
Plot 2	01 FFL	Store	1.7 m ²
Plot 2	01 FFL	Lift	1.8 m²
Plot 2	01 FFL	Bed 1	18.0 m²
Plot 3	00 FFL	Kitchen/ Living	26.2 m²
Plot 3	00 FFL	WC	2.8 m ²
Plot 3	00 FFL	Store	1.8 m ²
Plot 3	01 FFL	Bed 1	17.4 m²
Plot 3	01 FFL	Bath	4.9 m ²
Plot 3	01 FFL	Bed 2	11.5 m²
Plot 3	01 FFL	Bed 3	10.4 m ²
Plot 3	01 FFL	Store	0.9 m ²
Plot 4	00 FFL	Kitchen/ Living	26.9 m²
Plot 4	00 FFL	WC	3.6 m ²
Plot 4	00 FFL	Lift	1.8 m²
Plot 4	01 FFL	Store	1.6 m ²
Plot 4	01 FFL	Lift	1.8 m²
Plot 4	01 FFL	Store	1.7 m ²
Plot 4	01 FFL	Bed 1	18.0 m²
Plot 4	01 FFL	Bed 2	12.9 m²
Plot 4	01 FFL	Bath	5.7 m ²
Plot 5	00 FFL	WC	2.8 m²
Plot 5	00 FFL	Kitchen/ Living	26.3 m²
Plot 5	00 FFL	Store	1.8 m²
Plot 5	01 FFL	Bed 1	17.4 m²
Plot 5	01 FFL	Store	0.9 m ²
Plot 5	01 FFL	Bath	4.9 m ²
Plot 5	01 FFL	Bed 2	12.5 m ²
Plot 5	01 FFL	Bed 3	9.7 m²



DWW DESIGN | FIELD HOUSE | STATION APPROACH | HARLOW CM20 2FB

CLIENT

Harlow Council

JOB TITLE

Pytt Field, Harlow

DRAWING TITLE

Proposed Terrace Plans

Drawing status:	PLANNIN	Scale:		
JH	KC	MC	01/03/22	
Drawn:	Checked:	Appr:	Date:	
Job/ Dwg No/ Rev:	HD21050	1010	6	


1 : 100 @A1



1 Front (West) Elevation 1:100



Rear (East) Elevation 1:100

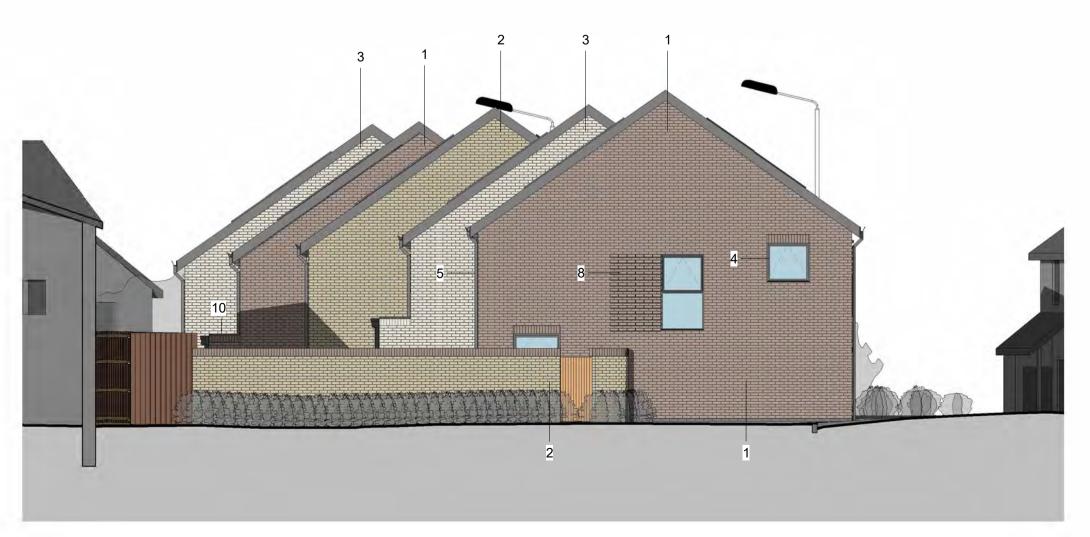






Side (South) Elevation
1:100

Rev	Date	Issued	Checked	Description
		by	by	·
1	28/06/22	KC	МС	Option with revised roofscape issued to client for comment
2	05/07/22	МС	МС	Pre-application issue
3	22/12/22	KC	МС	Post pre-application design update
4	20/01/23	KC	МС	Interim issue for consultant reports
5	02/02/23	KC	МС	Update to fenestration on south elevation
6	10/02/23	KC	МС	Planning Issue

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Material Key



1. Red multi stock brick

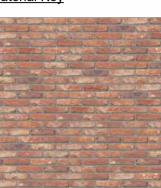


2. Buff multi stock brick

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3. Cream brick

- 4. Grey aluminium windows
- 5. Grey aluminium rainwater goods
- 6. Hit and miss timber screening
- 7. Fibre cement roof tiles with integral solar panels
- 8. Protruding brick banding detail
- . Grey powder coated steel balustrade
- Grey powder coated aluminium coping
- 11. Obscured windows to bathrooms or WC's
- Grey fibre cement roof tiles with integrated photovoltaic panels

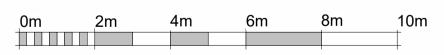

VISUAL SCALE 1:100 @ A1



DWW DESIGN | FIELD HOUSE | STATION APPROACH | HARLOW CM20 2FB

CLIENT

Harlow Council

JOB TITLE

Pytt Field, Harlow

DRAWING TITLE

Proposed Terrace Elevations

Drawing status:	PLANNIN	Scale:	
JH	KC	MC	09/03/22
Drawn:	Checked:	Appr:	Date:
Job/ Dwg No/ Rev:	HD21050	2010	6

As indicated @A1